

LOCATION MAP SCALE: N.T.S

PROPERTY ADDRESS: 301 CHAPIN STREET SOUTH BEND, IN 46601

LEGAL DESCRIPTION:

IDHS PROJECT NUMBER: 414445

OWNER:

SOUTH BEND HERITAGE FOUNDATION 803 LINCOLN WAY WEST SOUTH BEND, IN 46616 TEL: 574-289-1066 FAX: 574-289-4550

ARCHITECT:

SOUTH BEND HERITAGE FOUNDATION PATRICK LYNCH AR19900085 803 LINCOLN WAY WEST SOUTH BEND, IN 46616 CELL (574)286-0816 FAX (574)289-4550

ENERGY CODE:

BUILDING BUILT BEFORE 1970. EXEMPT.

BUILDING CODE: InBC 2014 - CHAPTER_34 BUILDING TYPE OCCUPANCY

SPRINKLERS

OCCUPANCY: S-2 (LOW HAZARD) NONE OCCUPANCY: B NONE OCCUPANCY: R-3NFPA 13R

FIRE ALARM EXISTING PULL BOXES AT FIRST FLOOR B R2 PER 907.2.9

STORIES 2 OVER BSMT

S2 OCCUPANCY (LOWER LVL) 300/GROSS = 7 PERSONS100/GROSS = 19 PERSONSB OCCUPANCY (1ST FLR) R3 OCCUPANCY (2ND FLR) 200/GROSS = 10 PERSONS

LOWER LEVEL S2 AREA: GROSS 1,815 SF GROSS 1,815 SF FIRST FLOOR B AREA: SECOND FLOOR R3 AREA: GROSS 1,815 SF BUILDING TOTAL: 5,445 SF

ZONING JURISDICTION: CITY OF SOUTH BEND

NC (NEIGHBORHOOD CENTER) **ZONING:**

PARKING

PROPOSED USE: R3 OVER EXISTING B

PARKING REQ'D FOR RETAIL: NONE REQUIRED FOR NC ZONING PARKING REQ'D FOR R3: NONE REQUIRED FOR NC ZONING 24 + 2 ADA EXISTING SPACES PROVIDED:

DRAWING INDEX

GENERAL NOTES & DRAWING INDEX

CHAPTER 34 SUMMARY FOR UNSEPARATED R-3 OVER B OVER S-2

CHAPTER 34 SUPPORTING CALCULATIONS

A0.4 SITE PLAN

LS1.0 LIFE SAFETY PLANS - EGRESS & OCCUPANCY

SECOND FLOOR DEMO PLAN FIRST FLOOR WALL PLAN

SECOND FLOOR WALL PLAN

ROOF PLAN AND ROOF HVAC

EXTERIOR STAIR

DOOR AND FINISH SCHEDULES

BUILDING SECTION


SECOND FLOOR LIGHTING & REFL. CLG. PLAN

SECOND FLOOR HVAC PLAN P1.0 PLUMBING ISOMETRIC & DETAIL

SECOND FLOOR POWER & DATA PLAN

ELECTRIC PANELS

FA1.0 FIRST & SECOND FLOOR FIRE ALARM PLAN

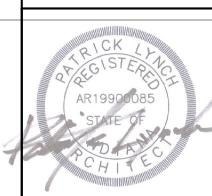

REVISIONS 1 04-13-20 BLDG SECTIO 07-01-20 R-3 FROM R-2

Permit Set

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Gen Notes Drawing Index Vicinity Map

Sheet Number: A0.1

	FIRE SAFETY TABULATION - CHAPTER 34 InBC 2014 (IBC 2012 + IN amendments)	S-2 OCC	VALUE	SMT)
	InBC 2014 (IBC 2012 + IN amendments) Unseparated occupancies for calculations: S-2, B, & R-3 & const type III-B	Fire Safety	Means of Egress	General Safety
3412.2.2	Existing basement S-2 to remain. Existing unseparated occupancy with B above.	S-2	S-2	S-2
3412.6 3412.6.1	Therefore all occupancies analyzed. Lowest # for each category is used. building height	3.00	3.00	3.00
	existing max ht 51: 0' above grade plane 0' EBH			
	table 503 allowable height (AH) in ft for III-B: $55' AH (55-0)/12.5 = 4.4$ AH - EBS = +ve value			
	ht ext'g in stories: 1 EBS (3 x 1) x 1 = 3 table 503 S-2 occupancy stories allowed: 3 AS (enter the lesser value)			
3412.6.2	building area	8.50	17.00	17.00
IBC 2012	flr area S1 occ: 1,825 sf sec 506.3 0% incr for NFPA13R sprink NA 0 table 503 max flr area allowed for S-2 occ & III-B const: 26,000 sf			
	sec 506.2 area increases for frontage 0 sf AA = (from 3412.6.2.1 formula) 26,000 sf			
	26000/1,200=21.67 21.67 [1-(1825/26000)] 21.67(.93)= 20.15			
	(score cannot exceed 50% of each value in 3412.8! 17/2 = 8.5; 34/2=17)			
3412.6.3	compartmentalization - unseparated occupancies unseparated occupancies. Therefore, fire compartment is three floors added together = 5,475 sf	14.00	14.00	14.00
	By linear interpolation, 5,475 sf is equivalent to approx 14.0 on table 3412.6.3			
3412.6.4	tenant and dwelling unit separation only one tenant within the floor area - mechanical space category 'c' = 0	0.00	0.00	0.00
3412.6.5	corridor walls category 'c' - 1 hr to less than 2 hr w/ drs per 715 or w/o corr walls if permitted = 0	0.00	0.00	0.00
3412.6.6	vertical openings VO = PV x CF			
	stair up from bsmt to 1st flr. Construction type factor for III-B is 3.5.	3.50	3.50	3.50
3412.6.7	hvac systems bldg type III-B - each HVAC units serve only one story = 5	5.00	5.00	5.00
3412.6.8	automatic fire detection Smoke detectors throughout the S-2 occupancy = category 'e" = 6	8.00	8.00	8.00
3412.6.9	fire alarm systems S occupancy in compliance with Section 907 category 'c'=10	10.00	10.00	10.00
3412.6.10		****	0.00	0.00
3412.6.11	means of egress capacity and number (for entire unseparated bldg) exit capacity category 'b' = 0	****	0.00	0.00
3412.6.12		****	2.00	2.00
971L:V:1L	dead ends		2.00	2.00
JTL:V:IL	dead ends occupancy type S-2 - category 'c' no dead end corridors = 2		2.00	2.00
	occupancy type S-2 - category 'c' no dead end corridors = 2 maximum travel distance complies with the limits set by the bldg code per 1016.1		2.00	2.00
3412.6.13	occupancy type 5-2 - category 'c' no dead end corridors = 2 maximum travel distance	****	14.33	14.33
3412.6.13	occupancy type S-2 - category 'c' no dead end corridors = 2 maximum travel distance complies with the limits set by the bldg code per 1016.1 max travel distance = 300' for S-2 per			
3412.6.13 3412.6.14	occupancy type S-2 - category 'c' no dead end corridors = 2 maximum travel distance	****	14.33	14.33
3412.6.13	occupancy type S-2 - category 'c' no dead end corridors = 2 maximum travel distance	*****	14.33	14.33
3412.6.13 3412.6.14 3412.6.15	occupancy type S-2 - category 'c' no dead end corridors = 2 maximum travel distance	*****	14.33	14.33
3412.6.13 3412.6.14 3412.6.15	occupancy type S-2 - category 'c' no dead end corridors = 2 maximum travel distance	*****	14.33	14.33
3412.6.14 3412.6.15 3412.6.16	occupancy type S-2 - category 'c' no dead end corridors = 2 maximum travel distance	*****	14.33	14.33
3412.6.14 3412.6.15 3412.6.16	maximum travel distance complies with the limits set by the bldg code per 1016.1 max travel distance = 300' for S-2 per S-2 = 85' actual max travel distance elevator control no elevator in building = 0 egress lighting full compliance - emergency power backup - category 'b" mixed uses non compliant with 3412.6.16.1 catagories. Therefore = 0 per 3412.6.16 Also, per 3412.6, each occ to be eval separately. Lowest score for ea section automatic sprinklers for S-2 not required for S-2 but required and provided for R-3. category 'd' required in R-3 portion and provided in R-3 portion = 3	***** 0.00 *****	14.33 0.00 1.00 *****	14.33
3412.6.14 3412.6.15 3412.6.16	occupancy type 5-2 - category 'c' no dead end corridors = 2 maximum travel distance complies with the limits set by the bldg code per 1016.1 max travel distance = 300' for S-2 per S-2 = 85' actual max travel distance elevator control no elevator in building = 0 egress lighting full compliance - emergency power backup - category 'b" mixed uses non compliant with 3412.6.16.1 catagories. Therefore = 0 per 3412.6.16 Also, per 3412.6, each occ to be eval separately. Lowest score for ea section automatic sprinklers for S-2 not required for S-2 but required and provided for R-3.	***** 0.00 *****	14.33 0.00 1.00 *****	14.33
3412.6.14 3412.6.15 3412.6.16	maximum travel distance complies with the limits set by the bldg code per 1016.1 max travel distance = 300' for S-2 per S-2 = 85' actual max travel distance elevator control no elevator in building = 0 egress lighting full compliance - emergency power backup - category 'b" mixed uses non compliant with 3412.6.16.1 catagories. Therefore = 0 per 3412.6.16 Also, per 3412.6, each occ to be eval separately. Lowest score for ea section automatic sprinklers not required for S-2 but required and provided for R-3. category 'd' required in R-3 portion and provided - category 'b' standpipes not required and not provided - category 'b'	***** 0.00 ***** 0.00	14.33 0.00 1.00 *****	14.33
3412.6.14 3412.6.15 3412.6.16 3412.6.17	occupancy type S-2 - category 'c' no dead end corridors = 2 maximum travel distance	***** 0.00 ***** 0.00 0.00	14.33 0.00 1.00 ***** (x/2) 1.50	14.33 0.00 1.00 3.00

	FIRE SAFETY TABULATION - CHAPTER 34 InBC 2014 (IBC 2012 + IN amendments)	B OCCU	PANCY (1st VALUE	Floor)	
	Unseparated occupancies for calculations: S-2, B, & R-3 & const type III-B	Fire Safety	Means of Egress	General Safety	
3412.2.2	Existing B occupancy to remain. Unseparated from exist'g S1 below and new R2 above.	В	В	В	
3412.6 3412.6.1	Therefore all occupancies analyzed. Lower # for each category is used. building height	3.00	3.00	3.00	
	existing max ht exist'g B: 10' above grade plane 10' EBH				
	table 503 allowable height (AH) in ft for III-B: 55' AH (55-10)/12.5 = 3.6 AH - EBS = positive value				
	table 503 B occupancy stories allowed: 1 (4-1) x 1 = 3 4				
3412.6.2	building area	12.00	14.31	14.31	
	flr area existing B occ: 1,825 sf sec 506.3 0% incr for sprink NA 0				
IBC 2012	table 503 max flr area for B occ & III-B const: 19,000 sf				
	sec 506.2 area increases for frontage 0 sf AA = (from 3412.6.2.1 formula) 19,000 sf (1,200 is a given in the equation) 19,000/1,200=15.83 15.83 [1-(1825/19000)] 15.83(.904)=14.31				
	(score cannot exceed 50% of each value in 3412.8! 24/2 = 12; 34/2=17)				<u>[</u>
3412.6.3	compartmentalization - unseparated occupancies 2 hr is req'd but existing horz. Btw R-3 above and B is less than 1 hour. Therefore, compartment is three both floors added together = 5475 sf	14.00	14.00	14.00	
	By linear interpolation, 5,475 sf is equivalent to approx. 14 on table 3412.6.3				
3412.6.4	tenant and dwelling unit separation				
	1 hr btw B and R-3 above category 'c' = 0	0.00	0.00	0.00	
3412.6.5	corridor walls category c = 1 hr to less than 2 hr w/drs per 715 or w/o corr walls if permitted = 0	0.00	20.00	0.00	
3412.6.6	category 'c' - 1 hr to less than 2 hr w/ drs per 715 or w/o corr walls if permitted = 0 vertical openings VO = PV x CF	0.00	0.00	0.00	_
3412.0.0	B occupancy is first floor and is one story per 3412.6.6, one story building PV = 2	7.00	7.00	7.00	
	CF Const type factor for III-B is 3.5				R-3
3412.6.7	hvac systems bldg type III-B - HVAC units serve only one story = 5	5.00	5.00	5.00	8 ⊗
3412.6.8	automatic fire detection Smoke detectors throughout the B occupancy = category 'e" = 8	8.00	8.00	8.00	BTW
3412.6.9	fire alarm systems	0.00	0.00	0.00	HORZ.
3412.6.10	in compliance with Section 907 category 'c' = 0 smoke control none = 0	****	0.00	0.00	OUR H
3412.6.11	means of egress capacity and number (for entire unseparated bldg) exit capacity category 'b' = 0	****	0.00	0.00	+ + + + + + + + + +
3412.6.12	dead ends	****	2.00	2.00	[[
	occupancy B - category 'c' no dead end corridors = 2				
3412.6.13	maximum travel distance				
	complies with the limits set by the bldg code per 1016.2				
	max travel distance = 200' for B unsprinkled B = 70' actual max travel distance (200'-70')/200' x 20 = 13	****	13.00	13.00	
3412.6.14	elevator control	0.00	0.00	0.00	<u>г</u>
	no elevator in 1 story bldg = 0	5,50			
3412.6.15	egress lighting full compliance - emergency power backup - category 'b" = 1	****	1.00	1.00	
3412.6.16	mixed uses	0.00	****	0.00	· [
	non compliant with 3412.6.16.1 catagories. Therefore = 0 per 3412.6.16				
	Also, per 3412.6, each occ to be eval separately. Lowest score for ea section				
3412.6.17	automatic sprinklers (scoring revised per IAC amendments for B occupancy) may be required to meet chap 9 via 508 = 0	3.00	(x/2) 1.50	3.00	
	Req'd in R-3 portion and provided in R-3 portion only - category 'd' = 3				
		<u> </u>			[-
3412.6.18	standpipes not required and not provided - category 'b' not required but provided at grade - category 'd'	0.00	0.00	0.00	_
	not required but provided at grade - category 'd' incidental use per 508.2.				ſ
	not required but provided at grade - category 'd'	0.00	0.00	0.00	
3412.6.18 3412.6.19	not required but provided at grade - category 'd' incidental use per 508.2.				

loor)			FIRE SAFETY TABULATION - CHAPTER 34 InBC 2014 (IBC 2012 + IN amendments)	R-3 OCC	CUPANCY (2 VALUE	nd FIr)
General Safety			Unseparated Occupancies for calculations: S-2, B, & R-3 & const type III-B	Fire Safety	Means of Egress	General Safety
В		3412.2.2 3412.6	Partial change in occupancy to second floor in bldg w/ non-separated occupancies Therefore all occupancies analyzed. Lower # for each category is used.	R-3	R-3	R-3
3.00		3412.6.1	building height existing max ht R-3: 22' above grade plane 22' EBH	2.00	2.00	2.00
			table 503 allowable height (AH) in ft for III-B: $55' \text{ AH} = (55-22)/12.5 = 2.64$ AH - EBS = +ve value ht ext'g in stories: 2 $(4-2) \times 1 = 2$			
			table 503 R-3 occupancy stories allowed: 4			
14.31		3412.6.2	building area	8.50	17.00	17.00
		IBC 2012	flr area R-3 occ: (for 2 apt. units) sec 506.3 0% incr for NFPA13R sprink NA 0 table 503 max flr area for R-3 occ & III-B const: UL sf			
			sec 506.2 area increases for frontage 0 sf AA = (from 3412.6.2.1 formula) UL sf UL/1,200=UL			
			$UL \times [1-(1825/16000)] \\ UL \times (.93) = UL \\ (score cannot exceed 50\% of each value in table 3412.8! (Indiana amendments)$			
14.00		3412.6.3	compartmentalization - unseparated occupancies 2 hr is req'd but existing horz. Btw R-3 and B below is less than 1 hour. Therefore, fire compartment is three floors added together = 5,475 sf	13.00	13.00	13.00
			By linear interpolation, 5,475 sf is equivalent to approx 13.0 on table 3412.6.3			
0.00		3412.6.4	tenant and dwelling unit separation 1 hr btw apts AND 1 hr btw R-3 and B below (ASS'Y UL-L501) category 'c' = 0	0.00	0.00	0.00
0.00		3412.6.5	corridor walls category 'c' - 1 hr to less than 2 hr w/ drs per 715 = 0	0.00	0.00	0.00
7.00	R-3	3412.6.6	vertical openings VO = PV x CF = (-1 x 2 floors) stair is exterior. No openings w/I bldg. PV= -2 Construction type factor for III-B is 3.5. CF= 3.5	-7.00	-7.00	-7.00
5.00	B ⊗ F	3412.6.7	hvac systems bldg type III-B - each HVAC units serve only one story = 5	5.00	5.00	5.00
8.00	BTW	3412.6.8	automatic fire detection Smoke detectors throughout the R-3 occupancy = category 'e" = 6	6.00	6.00	6.00
0.00	10RZ.	3412.6.9	fire alarm systems in compliance with Section 907 category 'c'= 0	0.00	0.00	0.00
0.00	OUR!	3412.6.10	smoke control none = 0	****	0.00	0.00
0.00	_ T	3412.6.11	means of egress capacity and number (for entire building) exit capacity category 'b' = 0 1 exit req'd for R-3 up to 4 units and max travel 125' per 1021.2	****	0.00	0.00
2.00		3412.6.12	dead ends occupancy R-3 - category 'c' no dead end corridors = 2 1 exit permitted for R-3 per 1021.2 exception 2	****	2.00	2.00
		3412.6.13	maximum travel distance complies with the limits set by the bldg code per 1016.2			
13.00			max travel dist. for R occ = 200' w/o sprinkler and 250' w/ sprinkler througout R-3 = 90' $\frac{1}{200'-90'}$ max travel distance $\frac{200'-90'}{200'}$ x $\frac{20}{200'}$ x $\frac{20}{200'}$	****	11.00	11.00
0.00		3412.6.14	elevator control no elevator in building = 0	0.00	0.00	0.00
1.00		3412.6.15	egress lighting full compliance - emergency power backup - category 'b"	****	1.00	1.00
0.00		3412.6.16	mixed uses	0.00	****	0.00
		3412.6.17	non compliant with 3412.6.16.1 catagories. Therefore = 0 per 3412.6.16 Also, per 3412.6, each occ to be eval separately. Lowest score for ea section automatic sprinklers for R-3		(x/2)	
3.00		3412.0.17	Meets 903 = 3.0 NFPA 13D is allowed for R-3 per 903.2.8.1 sprinkers are provided for R-3 only per category 'd' = 3	2.00	1.00	2.00
0.00		3412.6.18	standpipes not required and not provided - category 'b' standpipe shall meet 2012IBC 905.3	0.00	0.00	0.00
0.00		3412.6.19	incidental use per 508.2. no incidental use areas	0.00	0.00	0.00
70.31			TOTAL SCORE FOR R-3 OCCUPANCY:	29.50	51.00	52.00
34			MANDATORY (MIN.) SAFETY SCORES FOR ANY R OCCUPANCY: R-3 (min. score revised per InBC 2014 amendments)	17	34	34

SOUTH BEND HERITAGE FOUNDATION





REVISIONS

1 04-13-20 BLDG SECTION

2 07-01-20 R-3 FROM R-2

Permit

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Chapter 34
Supporting
Calculations

Sheet Number: A0.3

South Bend Heritage
803 Lincoln Way West South Bend, IN 46616 Phone: 574-289-1066 Fax: 574-289-4550 www.sbheritage.o
July 1, 2020
54., <u>1, 1525</u>
RE: project # 414445 – CHAPTER 34 compliance – change from R-2 to R-3
This project was previously submitted with R-2, S-2, and B unseparated occupancies. The previous
review process concluded that the Chapter 34 application was not sufficient to meet the requirements for a Certificate of Design Release
We have reviewed the project with RTM Consultants and determined that a change to R-3 dramatically
improves and clarifies the Chapter 34 scoring. A change to R-3 removes the requirement for sprinklers throughout the building and the associated point penalty in 3412.6.17. Per 675 IAC 13-2.6-10 amendment to 903.2.8.
We will still provide 1 hour separation between the two R-3 units and between the R-3 and B below.
Please let me know if there are any questions or concerns about this change. Thank you.
Regards,
Antitul
Patrick Lynch
Architect

	,	Table 341	2.7 SUMMARY SHEE	T - BUILDING	CODE		
Existing occupancy	VACANT				Proposed occupancy	R-3	
Year building was constructed	1890				Number of stories	1 Height in	feet 22'
Type of construction	III-B				Area per floor	1575 SF	
Percentage of open perimeter inc		C) %				
Completely suppressed:	Yes		No		Corridor wall rating	1 HR	
Compartmentation:	Yes		No		Req'd door closers:	Yes	No
Fire resistance rating of vert. ope	_		1HR				
Type of HVAC system:	HEAT PUMP	<u> </u>	N.I		_, serving number of f		
Automatic fire detection:	Yes		No			Type and location	smoke detectors
Fire alarm system: Smoke control:	Yes		No			Type	per 907
Adequate exit routes:	Yes Yes		No No			Type Dead ends:	NA NONE
Maximum exit access travel dista		97' (Actua				Elevator controls:	NA
Means of egress emergency lighti	_	37 (Actua	Yes			Lievator Controls.	NA .
Existing occupancy	В.	Table 341	2.7 SUMMARY SHEE	T - BUILDING	CODE Proposed occupancy	same	
Year building was constructed	1890				Number of stories	1 Height in	feet 10'
Type of construction	III-B				Area per floor	1475 SF	
Percentage of open perimeter inc		C) %		- -		
Completely suppressed:	Yes		No		Corridor wall rating	1 HR	
Compartmentation:	Yes		No		Req'd door closers:	Yes	No
Fire resistance rating of vert. ope	ning enclosu	res	1HR				
Type of HVAC system:	Gas Furnace	e w/ AC	(Roof-top compresso	or)	_, serving number of f	loors ONE	
Automatic fire detection:	Yes		No			Type and location	smoke detectors
Fire alarm system:	Yes		No			Type	manual pull alarms
Smoke control:	Yes		No			Type	NA
Adequate exit routes:	Yes		No			Dead ends:	NONE
Maximum exit access travel distal Means of egress emergency lighting	_	67' (Actua	l) Yes	No		Elevator controls:	NA
		Table 341	2.7 SUMMARY SHEE	ET - BUILDING	CODE		
Existing occupancy	S-2				Proposed occupancy	same	
Year building was constructed	1890				Number of stories	1 BSMT Height in	feet 10'
Type of construction	III-B				Area per floor	1475 SF	
Percentage of open perimeter inc	rease	C	<u>%</u>				
Completely suppressed:	Yes		No		Corridor wall rating	1 HR	
	Yes		No		Req'd door closers:	Yes	No
Compartmentation:			1HR				
Fire resistance rating of vert. ope	•						
Fire resistance rating of vert. ope Type of HVAC system:	not condition				_, serving number of f		
Fire resistance rating of vert. ope Type of HVAC system: Automatic fire detection:	not condition		No		_, serving number of f	Type and location	smoke detectors
Fire resistance rating of vert. ope Type of HVAC system: Automatic fire detection: Fire alarm system:	not condition Yes Yes		No		_, serving number of f	Type and location Type	manual pull alarms
Fire resistance rating of vert. ope Type of HVAC system: Automatic fire detection: Fire alarm system: Smoke control:	rot condition Yes Yes Yes		No No		_, serving number of f	Type and location Type Type	manual pull alarms NA
Fire resistance rating of vert. ope Type of HVAC system: Automatic fire detection: Fire alarm system: Smoke control: Adequate exit routes:	rot condition Yes Yes Yes Yes	oned	No No		_, serving number of f	Type and location Type Type Dead ends:	manual pull alarms NA NONE
Fire resistance rating of vert. ope Type of HVAC system: Automatic fire detection: Fire alarm system: Smoke control:	rot condition Yes Yes Yes Yes rce		No No	No	_, serving number of f	Type and location Type Type	manual pull alarms NA

		Comb	ined lowest : (per 3412.6)	score
		Li	OWEST VALUE	
		Fire Safety	Means of Egress	General Safety
3412.6.1	bldg. height	2.00	2.00	2.00
3412.6.2	bldg. area	8.50	14.31	14.31
3412.6.3	compartmentalization (unseparated occupancies)	13.00	13.00	13.00
3412.6.4	tenant and dwelling unit separation	0.00	0.00	0.00
3412.6.5	corridor walls	0.00	0.00	0.00
3412.6.6	vertical openings	-7.00	-7.00	-7.00
3412.6.7	hvac systems	5.00	5.00	5.00
3412.6.8	automatic fire detection	6.00	6.00	6.00
3412.6.9	fire alarm systems	0.00	0.00	0.00
3412.6.10	smoke control	****	0.00	0.00
3412.6.11	means of egress	****	0.00	0.00
3412.6.12	dead ends	****	2.00	2.00
3412.6.13	maximum travel distance			
2412 5 4 5	alayatar acutus!	****	11.00	11.00
5412.6.14	elevator control	0.00	0.00	0.00
3412.6.15	egress lighting	****	1.00	1.00
3412.6.16	mixed uses	0.00	****	0.00
3412.6.17	automatic sprinklers	2.00	(x/2) 1.00	2.00
3412.6.18	standpipes	0.00	0.00	0.00
3412.6.19	incidental use	0.00	0.00	0.00
TOTAL:		29.50	51.00	52.00
	ORY MIN. SAFETY SCORES:	17	34	34 nassi
(PER 3412.	9.1)	pass!	pass!	pass!

PASSED

Sheet Number: A0.2

Chapter 34 Summary

Permit

Job Number:

Drafting: -Approval: PDL

AUG. 19, 2020

Set

SOUTH BEND HERITAGE FOUNDATION

STREET SPIN STREET, 8

CHAPIN 301 SO. CHAF


REVISIONS

1 04-13-20 BLDG SECTION
2 07-01-20 R-3 FROM R-2


Life Safety Plans

Sheet Number:


ACTUAL OCC S2 COMMON PATH = 100'.
MAX ALLOWED = 100' PER 1014.3

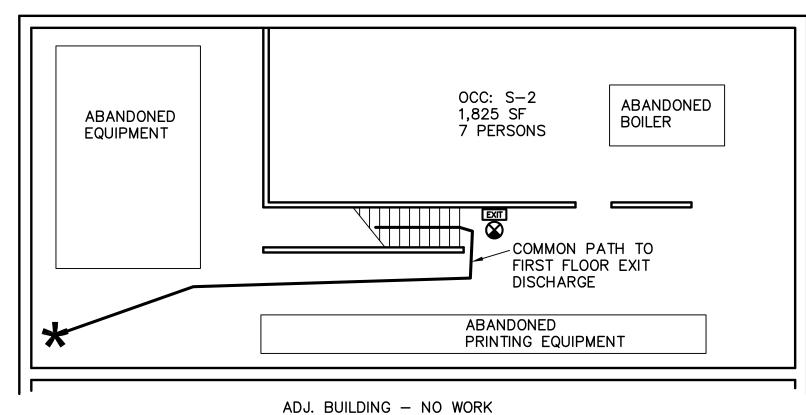


BASEMENT LIFE SAFETY PLAN

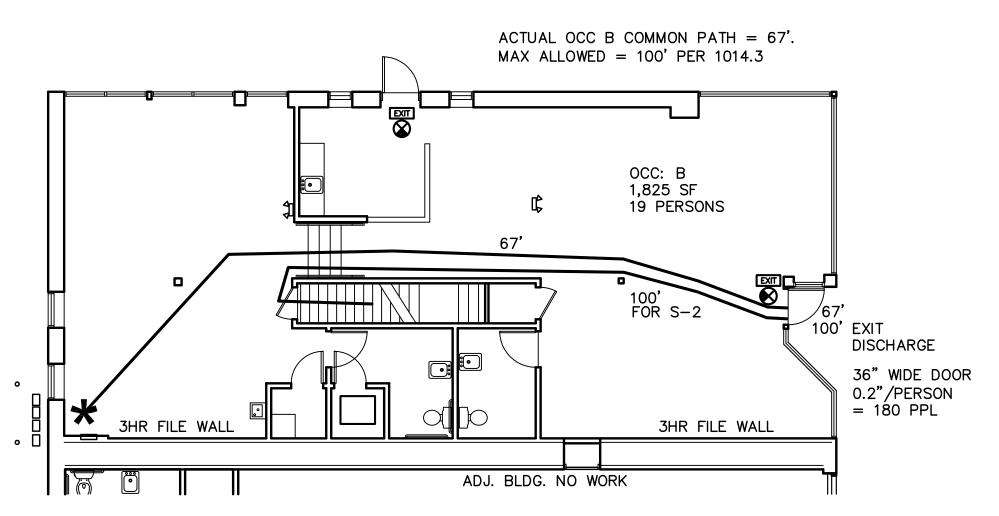

FIRST FLOOR LIFE SAFETY PLAN

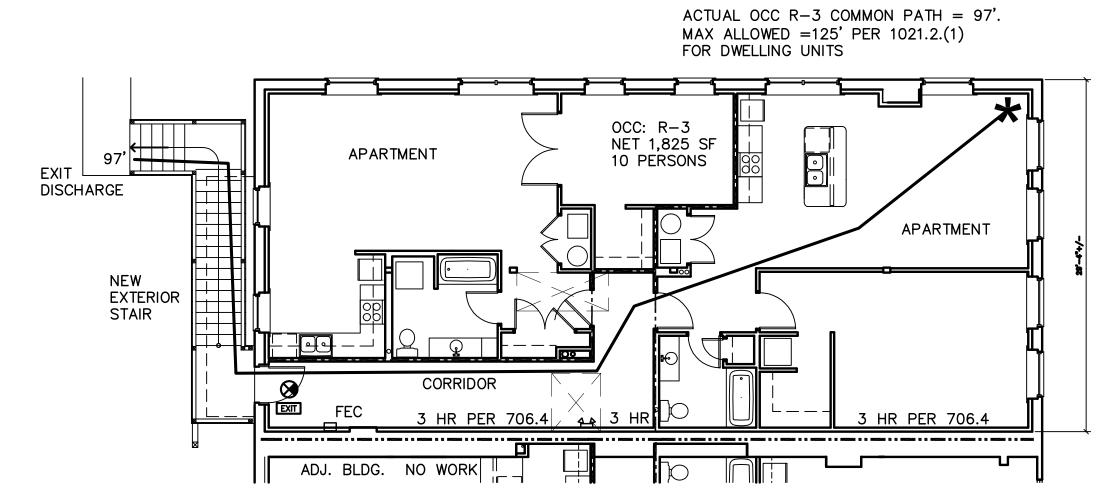

SECOND FLOOR LIFE SAFETY PLAN

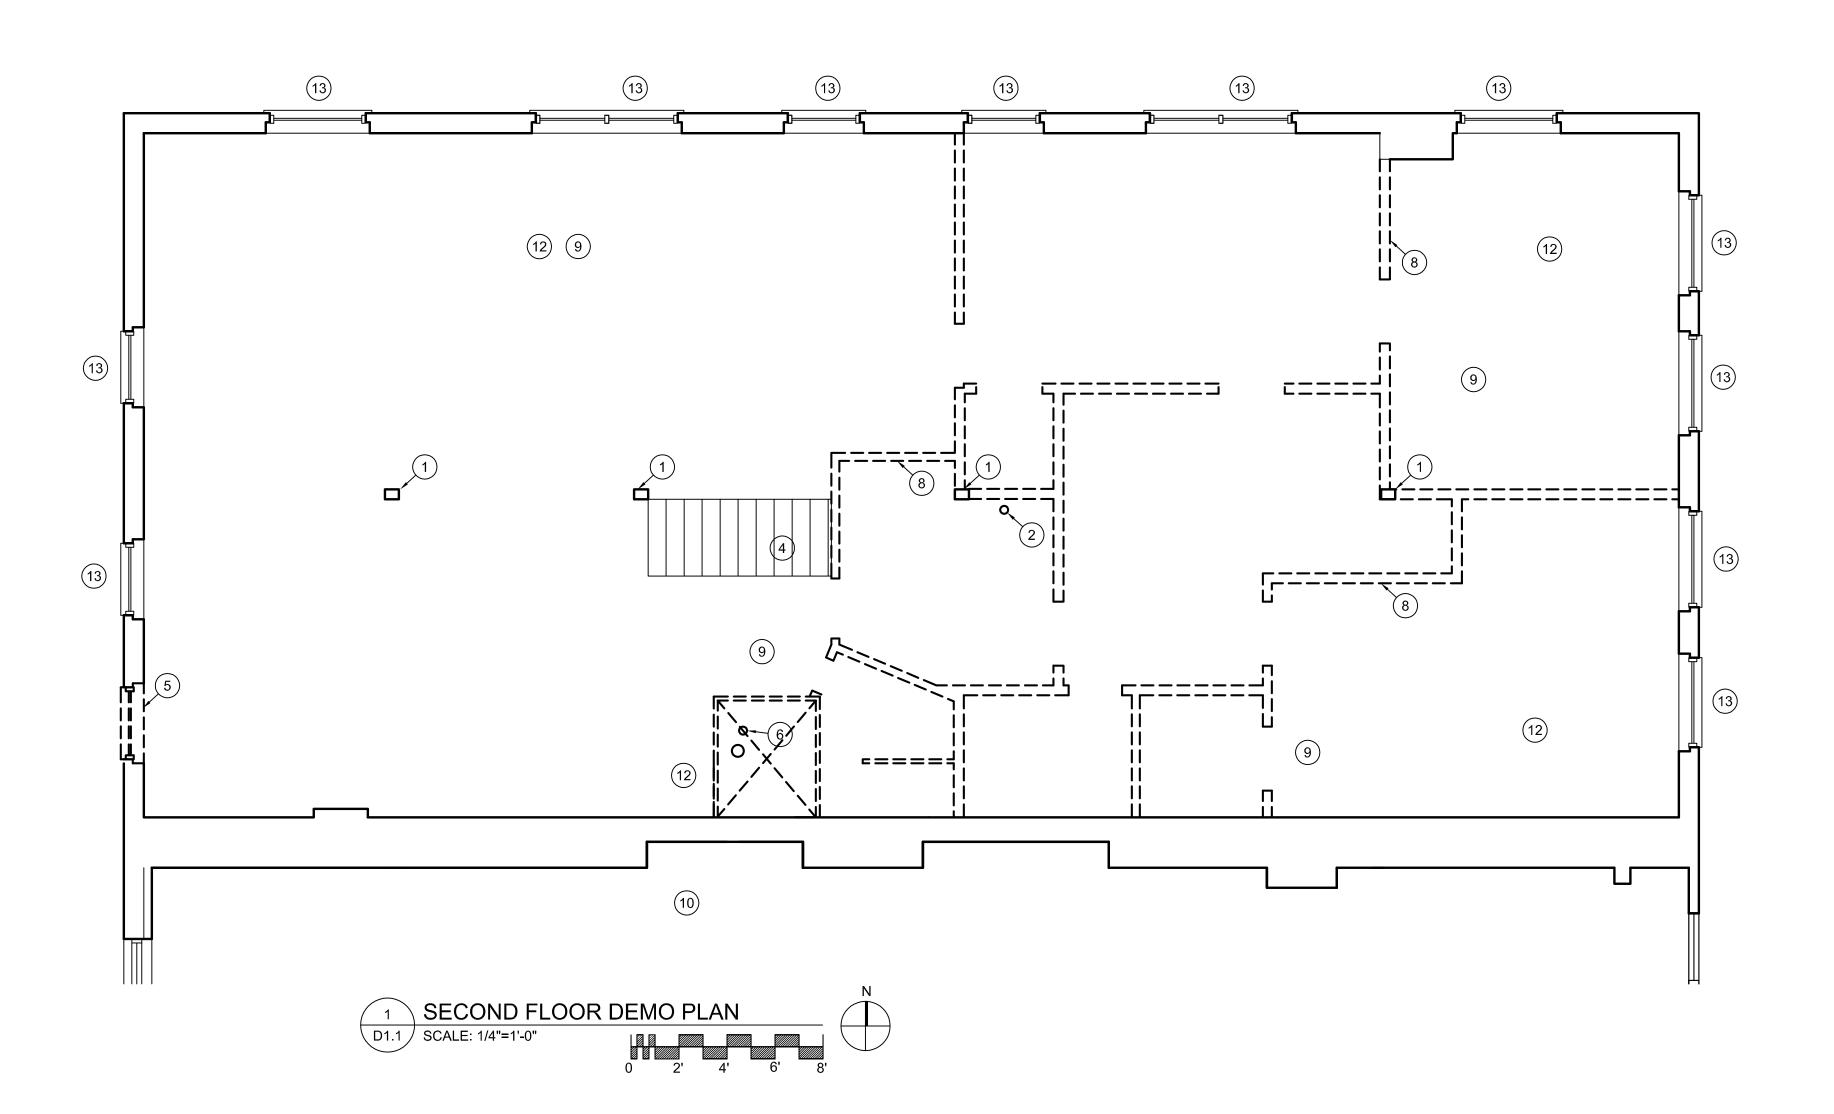

GENERAL NOTE: PRIOR TO DEMOLITION, INSPECT EXISTING STRUCTURE FOR: DAMAGE; DRY ROT,; LOOSE OR INADEQUATE FASTENERS TO POSTS AND BEARING POINTS; DAMAGED BRACING. REPORT ANY UNSAFE OR UNSTABLE CONDITIONS TO SBH IMMEDIATELY. PROVIDE TEMP. VERTICAL AND LATERAL BRACING AS REQUIRED.

- (2) EXISTING ROOF DRAIN PIPE TO BE RELOCATED.
- (3) OPEN EXISTING MANSORY WALL TO CONNECT BUILDINGS. STEEL LINTEL ABOVE. CENTER NEW OPENING ON EXISTING ADJACENT CORRIDOR.
- WITH 2x10 12" OC W/ 3/4" PLYWOOD DECKING. INSULATED WITH FIBERGLASS BATT. PROTECT
- RELOCATED PER NEW WALL PLAN.
- (7) REMOVE EXISTING FREIGHT ELEVATOR CONSTRUCTION. FRAME IN FLOOR OPENING SIMILAR TO AS DESCRIBED IN NOTE #4.
- (8) DASHED LINES INDICATE WALL STRUCTURE TO BE REMOVED. ALWAYS INSPECT WALL PRIOR TO REMOVAL TO ENSURE THAT ADEQUATE DIRECT AND LATERAL SUPPORT FOR REMAINING BUILDING ELEMENTS WILL REMAIN. MAINTAIN ADEQUATE BEARING BELOW ROOF STRUCTURE. ADD BRACING AS REQ'D. NOT ALL COLUMNS AND SUPPORTS MAY BE SHOWN. CONTACT ARCHITECT IMMEDIATLY IF CONFLICTS OR STRUCTURAL ISSUES ARE FOUND.
- THROUGHOUT SECOND FLOOR AREA.
- (11) ASSUME 320+/- SF OF TAPERED 2x SLEEPERS 16" OC AND 3/4" PLYWD DECKING TO BRING SUBFLOOR TO LEVEL IN MIDDLE 1/3 OF OVERALL FLOOR AREA.



- 1) EXISTING STRUCTURAL COLUMNS TO REMAIN.
- REFER TO ROOF PLAN FOR REVISED DRAIN
- (4) EXISTING STAIRWAY TO BE ABANDONED. FRAME OVER UNDERSIDE WITH 5/8" TYPE-X GWB.
- (5) REMOVE WINDOW AND MODIFY MASONRY FOR NEW DOORWAY RO. 5" LIMESTONE SILL.
- 6 EXISTING VENTS, ELECTRICAL, LINESETS, ETC. FOR FIRST FLOOR MECH. EQUIPMENT TO BE
- MECHANISM AND GUIDE WAYS AS REQ'D FOR NEW
- 9 REMOVE LATHE AND PLASTER CEILING
- (10) ADJACENT EXISTING. NO WORK.
- (12) NEW 3/4" OSB DECKING SCREWED TO EXISTING FLOORING AT AREAS OUTSIDE OF RAISED FLOOR AREA DESCRIBED IN ITEM #11.
- (13) EXISTING WINDOWS TO REMAIN.



OUTH BEND HERITAGE FOUNDATION

REVISIONS 1 04-13-20 BLDG SECTION 2 07-01-20 R-3 FROM R-2

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Demolition Plan


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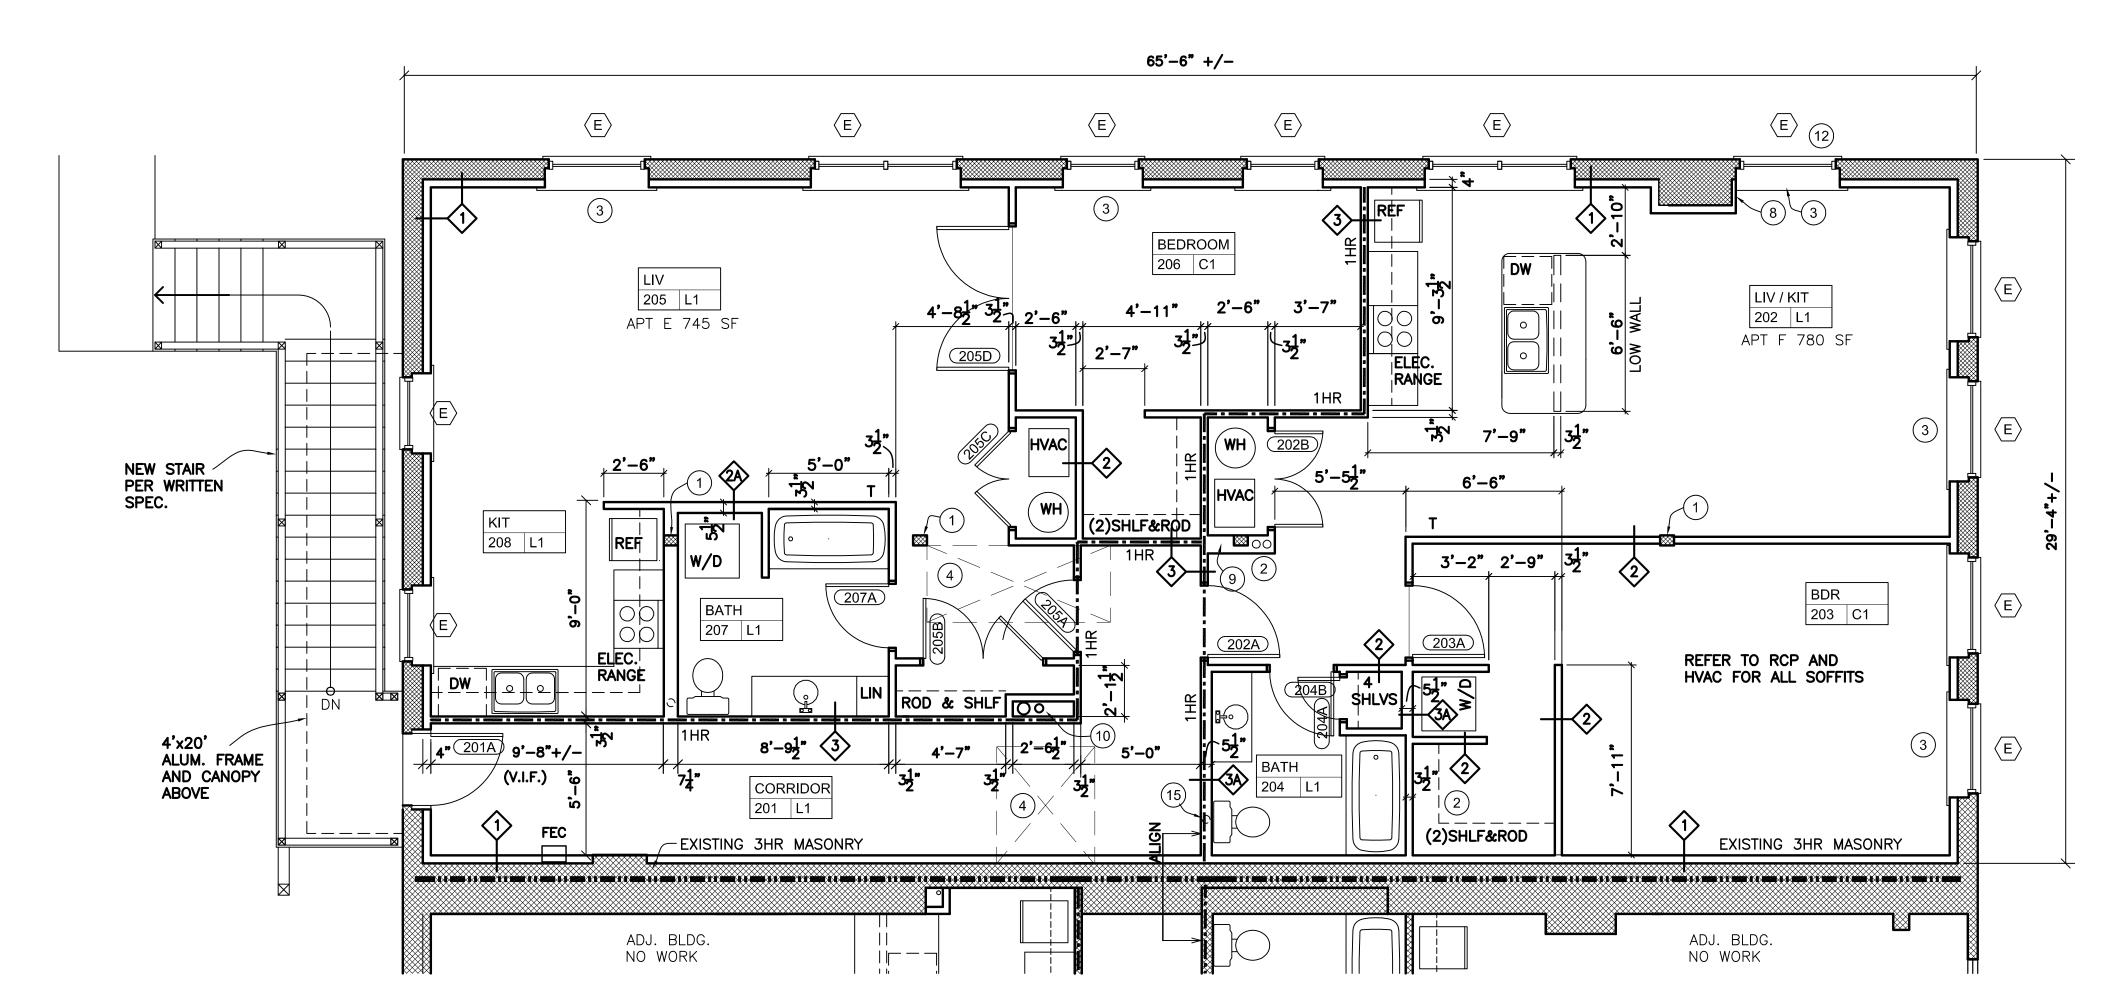
1st Floor

A2.0



DEMO NOTES

- 1) EXISTING FIRE ALARM PANEL. 2 NOT USED
- 3 NOT USED
- 4 EXISTING B OCCUPANCY. UNOCCUPIED.
- 5 EXISTING STAIR ABANDONED. SEE NOTES FOR INDICATED WALL TYPE.
- 6 ROOF DRAIN AND NEW OVERFLOW DRAIN LINES SEPARATE TO BASEMENT.
- 7 PROVIDE CHASE FOR WATER LINES IN WALL FOR SECOND FLOOR APARTMENTS AND FIRE SPRINKLER. PATCH AND PAINT AS REQ'D.
- 8 SUGGESTED ROUTE FOR SECOND LEVEL PLUMBING ABOVE FIRST FLOOR ACT CEILING TO EXISTING
- 9 CUT AND PATCH EXISTING WALL AS REQ'D FOR NEW MECHANCIAL. PAINT TO MATCH EXISTING.
- 10) ADJUST DOOR 101A TO CLOSE SMOOTHLY
- REMOVE DOOR & FRAME AT OPENING AND INSTALL NEW 3-HOUR WALL ASSEMBLY INFILLED INTO EXISTING MASONRY ROUGH OPENING. ASS'Y TO BE PER UL U419 FOR 3 HOUR WALL.

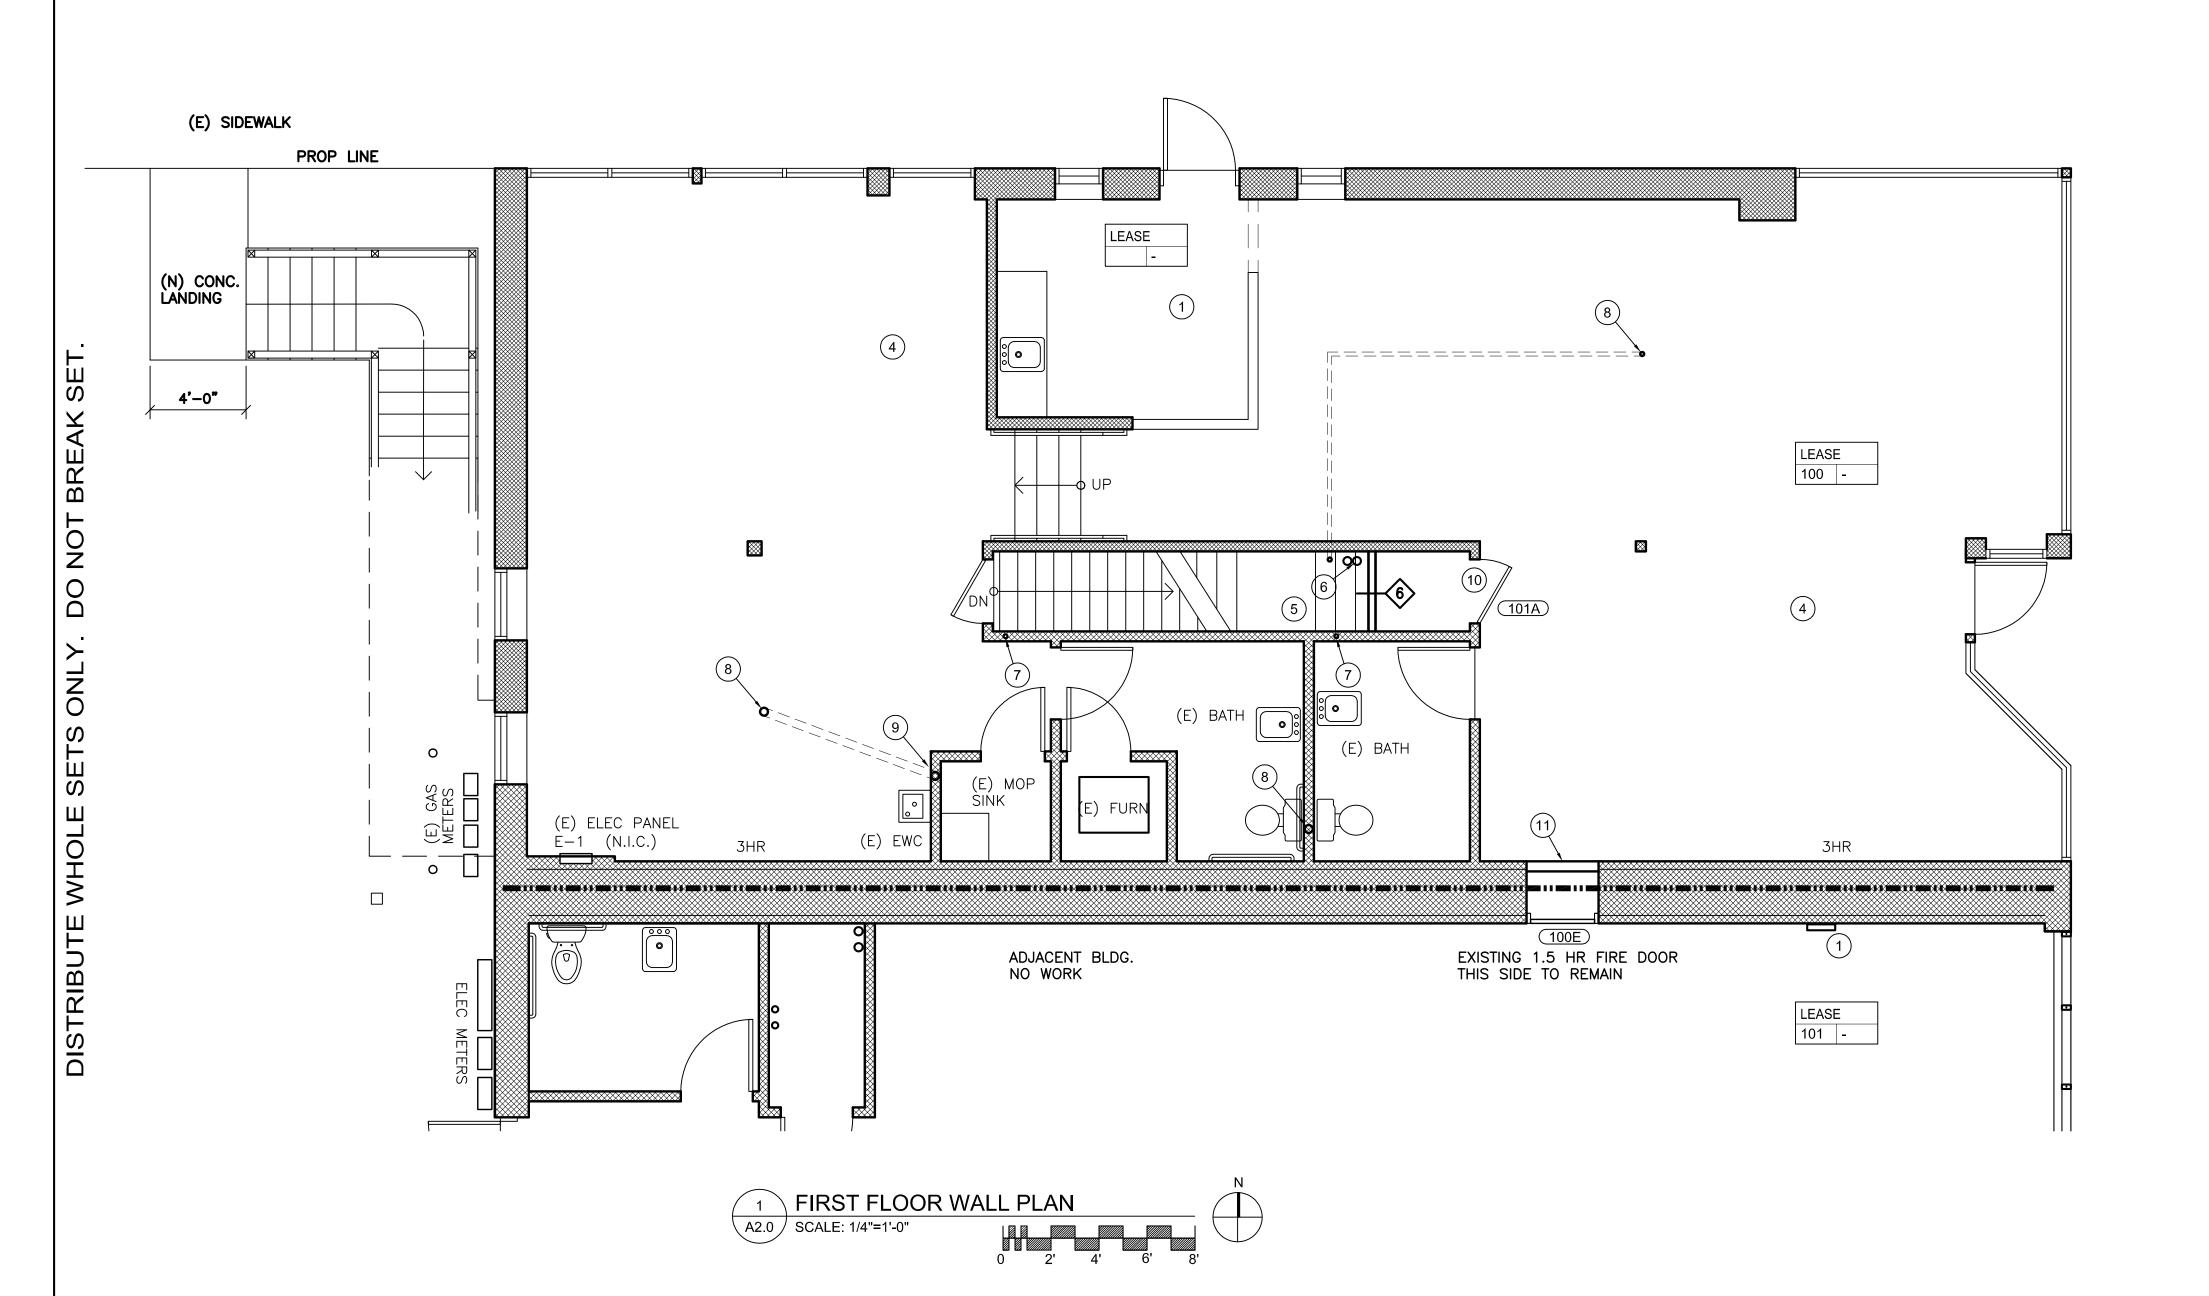

SECOND FLOOR WALL PLAN

\ A2.1 / SCALE: 1/4"=1'-0"

WALL & FLOOR ASSEMBLY TYPES

- 1 LAYER TYVEK DRAINVENT AGAINST EXISTING MASONRY WALL. THEN, 2x4 16" OC SET 1" AWAY FROM EXISTING MASONRY WALL; DENSE PACK CELLULOSE BEHIND INSULWEB; 5/8" GWB ONE SIDE; TRIM AND FINISH PER SCHEDULE.
- NOT USED.
- INTERIOR PARTITION: 2x4 16" OC W/ 5/8" GWB EACH SIDE. TRIM AND FINISH PER SCHEDULE.
- 2x6 16" OC W/ 5/8" GWB EACH SIDE. TRIM AND FINISH PER SCHEDULE.
- 3 1 HR PARTITION: 2x4 16" OC W/ SOUND ATTENUATION ROCKWOOK BATTING AND 5/8" GWB EACH SIDE. TRIM AND FINISH PER
 - FULL HEIGHT TO UNDERSIDE OF ROOF DECK.
- 1 HR PARTITION: 2x6 16" OC W/ SOUND ATTENUATION BATTING AND 5/8" TYPE-X GWB EACH SIDE. TRIM AND FINISH PER SCHEDULE. FULL HEIGHT TO UNDERSIDE OF ROOF DECK.
- LOW 2x4 WALL

2ND FLOOR PLAN NOTES

- FROM FLOOR TO UNDERSIDE OF ROOF DECK. POST NEED NOT BE FLUSH W/ ADJ. NEW WALL.
- RELOCATED TO VERTICAL CHASE THIS WALL.
- (3) NEW 1x4 CASING TRIM AT ALL WINDOWS. 5/4 WOOD SILL AND 1x4 APRON. MASONRY REPAIR AND STABILIZATION AS REQUIRED. 1X JAMB EXTENSIONS AS REQUIRED. PTD.
- FRAME ACROSS ABANDONED OPENING. NEW 3/4" PLYWD DECKING FLUSH TO EXISTING FLOOR.
- (5) NO WORK THIS AREA U.O.N.
- NO WORK THIS AREA.
- (7) REMOVE EXISTING WINDOW AND REPLACE EXISTING STEEL LINTEL. REPAIR SURROUNDING MASONRY AND LINTEL BEARING. REPAIR DISPLACED PARAPET ABOVE. REWORK EXISTING ROOF MEMBRANE AS REQUIRED AT REPAIR SITE.
- 8 FURRING AT WALL ONLY AS REQ'D TO ACCOMODATE WINDOW TRIM.
- 9 NFPA 13R SPRINKLER RISER AND WATER LINE
- 10) MECH VENTS TO ROOF FOR 1ST LVL EQUIPMENT RE-ROUTED TO THIS LOCATION
- (11) 3" SCHED 40 PB SANITARY DRAIN; 3" PVC ELEC. CONDUIT; AND 3/4" PEX WATER SUPPLY LINE
- (12) REPAIR BROKEN IG PANEL THIS WINDOW.

- (1) (1) LAYER 5/8" GWB AROUND 4 SIDES OF POST
- (2) ROOF DRAIN AND NEW OVERFLOW DRAIN

- (6) EXISTING FOLD DOWN ROOF ACCESS LADDER.


- FROM BSMT TO SECOND FLOOR.

EQUIPMENT NOTES

- FE 5LB ABC FIRE EXTINGUISHER. WALL HUNG.
- FEC RECESSED FIRE EXTINGUISHER CABINET W/ 10 LB ABC EXTINGUISHER

FIRE BARRIER SYMBOLS

- ____ 2 HOUR SEPARATION. REFER TO NOTED WALL TYPE.
- ____ 1 HOUR SEPARATION. REFER TO NOTED WALL TYPE.
- 3 HOUR SEPARATION. EXISTING MASONRY FIRE WALL BTW BUILDINGS.

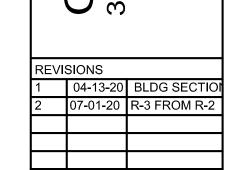


OUTH BEND HERITAGE FOUNDATION

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AUG. 19, 2020 Job Number: Drafting: -Approval: PDL

2nd Floor


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ROOF PLAN NOTES

- 1) EXISTING ROOF SCUTTLE MAY REMAIN.
- 2 EXISTI'G 1ST FLR FURNACE PENETRATIONS TO REMAIN.
- 3 FRAME AS REQ'D TO SUPPORT REPLACEMENT ROOF DRAIN THIS LOCATION. NEW DRAIN TO BE ZURN FROET C100 WITH OPTIONS AS NEEDED FOR EXISTING ROOF ASSEMBLY. DRAIN TO BE SEPARATED TO BASEMENT LEVEL.
- 4 EXISTING AC COMPRESSOR FOR 1ST FLOOR TO REMAIN.
- 5 NEW 24x24x12HT CURB. PROVIDE (3) VENT CAPS FOR DUCTS INDICATED ON HVAC PLAN M1.0.
- 6 SILVERCOAT EXISTING ROOF. NEW PENETRATIONS AS REQUIRED.
- (7) -
- 8 REMOVE OBSOLETE HVAC VENTS. NOT ALL VENTS SHOWN. ROOFING CONTRACTOR TO REFER TO MEP DRAWINGS AND COORDINATE IN FIELD.
- 9 EXISTING SANITARY STACK TO REMAIN

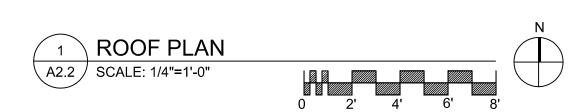



CHAPIN STREET, SOUTH BEND, IN 46601

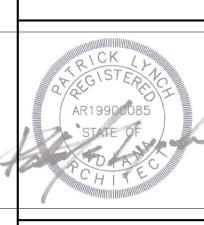REVISIONS											
1	04-13-20	BLDG SECTION									
2	07-01-20	R-3 FROM R-2									


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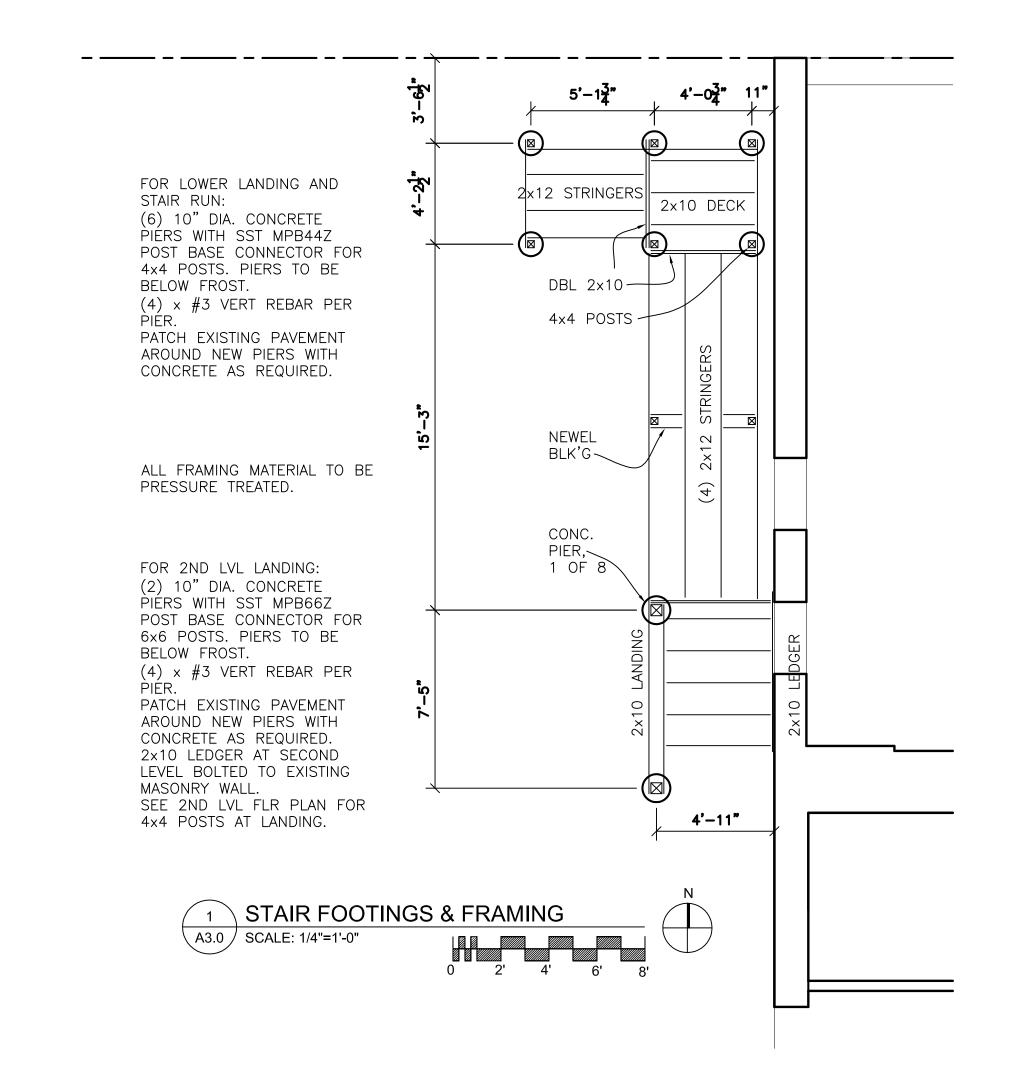
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Job Number:	
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Approval:	PDL


Roof Plan

Sheet Number:

A2.2



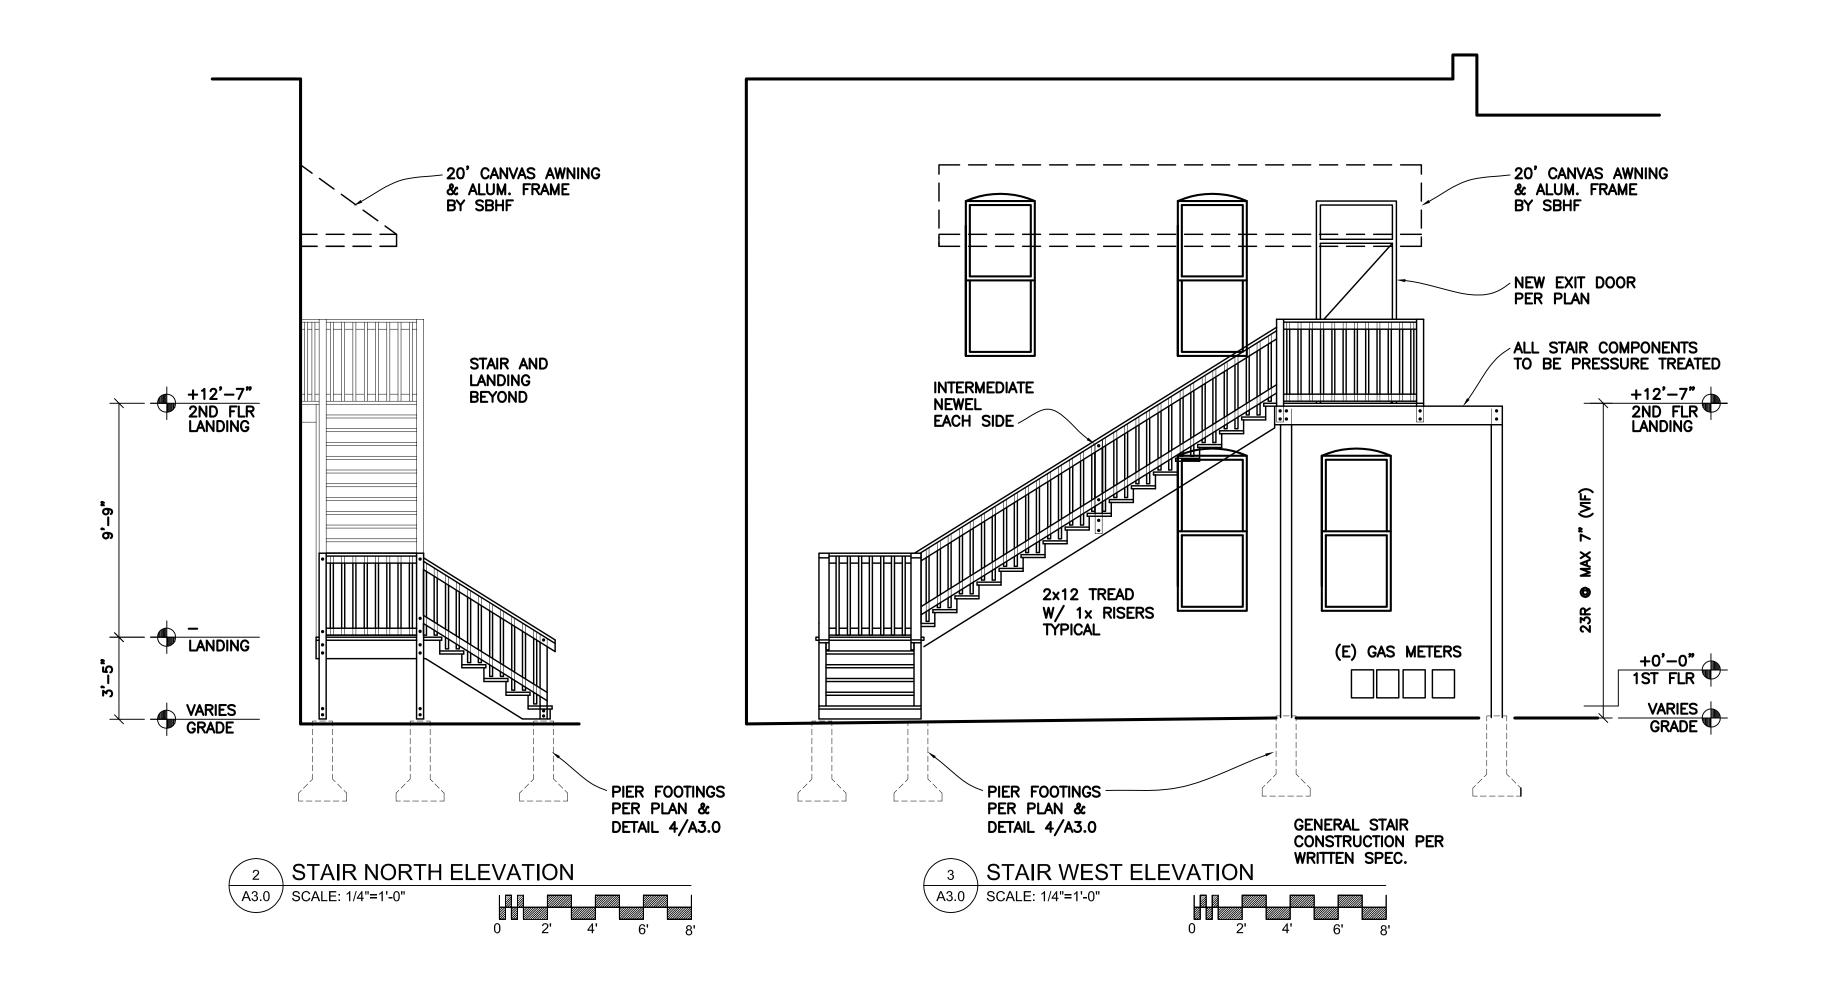

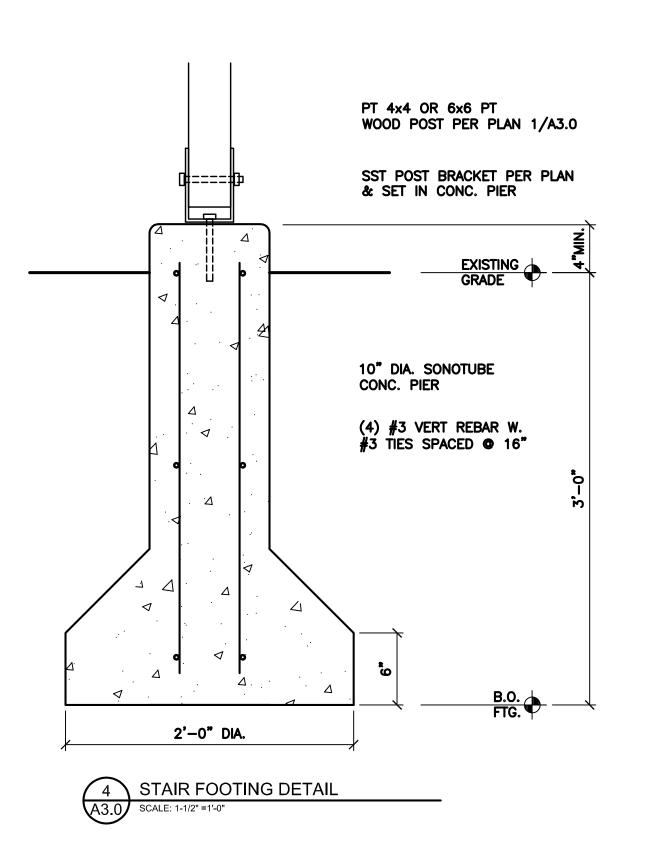

SOUTH BEND HERITAGE FOUNDATION

HONE (574)

STREET, APIS. E & F IN STREET, SOUTH BEND, IN 466

CHAPIN 301 SO. CHAI

Permit Set

Date: AUG. 19, 2020

Job Number:

Drafting:
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Stairway

Sheet Number:
A3.0

DOOR		DOOR, FRAM				FIRE	FRAMI						REMARKS
NO.	TYPE	SIZE	MAT	FIN	HDWR	LABEL	TYPE	MAT	FIN	HEAD	JAMB	THR	
	FLOOF				•					•	!		•
101A		EXISTING	WD		EXISTING	_							ADJUST TO CLOSET & LATCH
				ļ									
	ND FLC				i	i							
201A	D	3'-0" x 6'-8"	ALUM	_	MAIN ENTRY	_	BB	ALUM	_	-			STOREFRONT ENTRY W/ TRANSO
	+	-1 -2 -1 -2								+			
202A	A	3'-0" x 6'-8"	WD	STN		20 MIN	AA	WD	PTD				
202B		PR 2'-0" x 6'-8"			PASSAGE	_	CC	WD	PTD				BALL CATCH. DUMMY LEVERSETS
203A	C	2'-8" x 6'-8"	WD		PASSAGE	_	CC	WD	PTD	+			DATUBOOM DOOD
204A 204B	В	2'-8" x 6'-8" 2'-0" x 6'-8"	WD	1	PRIVACY		CC	WD	PTD	+			BATHROOM DOOR
20 4 0		2-0 x 6-6	WD	SIN	PASSAGE	-	CC	WD	PTD				
205A	A	3'-0" x 6'-8"	WD	STN	ENTRY	20 MIN	AA	WD	PTD	+			_
205B		PR 2'-6" x 6'-8"					CC	WD					BALL CATCH. DUMMY LEVERSETS
205C		PR 2'-0" x 6'-8"			PASSAGE		CC	WD	PTD				BALL CATCH. DUMMY LEVERSETS
205D		PR 2'-6" x 6'-8"			PASSAGE		CC	WD	PTD				BALL CATCH. DUMMY LEVERSETS
207A	В	2'-8" x 6'-8"	WD	t — —	PRIVACY		СС	WD	PTD				BATHROOM DOOR

GENERAL DOOR NOTES:

- 1. INSPECT ALL LISTED INTERIOR AND EXTERIOR DOORS FOR SMOOTH CLOSURE AND LATCH. ADJUST AS REQUIRED. 2. NOT ALL DOORS LISTED ARE USED. SOME ARE FUTURE CONST. COORDINATE SCHEDULES WITH FLOOR PLANS.
- 3. LEVER HARDWARE TO BE SCLAGE LEVER SETS
 SERIES LOCKSETS OR OWNER APPROVED EQUAL.
 INCLUDE WALL MOUNTED DOOR BUMPER FOR ANY LOCKSET
 THAT WILL CONTACT ADJACENT WALL WITHIN 110° FROM CLOSED.
- 4. ALL FIRE RATED DOORS TO RECEIVE AUTO CLOSERS AND SMOKE GASKETS

GENERAL HARDWARE NOTES:

- 1. ALL FIRE DOORS SHALL BEAR A PERMANENTLY AFFIXED LABEL SHOWING FIRE PROTECTION RATING PER 713.3
- 2. APPROVED FIRE DOOR HARDWARE AND DOOR FRAMES INCLUDING ANCHORAGE SHALL BE INSTALLED IN ACCORDANCE WITH THEIR LISTING PER 713.3
- 4. ALL FIRE RATED DOORS TO RECEIVE AUTO CLOSERS AND SMOKE GASKETS

- 5. KEYING NOTES:
- EACH TENANT KEY TO BE UNIQUE. SINGLE MASTER FOR ALL APARTMENTS AND CHAPIN STREET ENTRY DOOR.
- 6. APARTMENT ENTRY HARDWARE
- EXISTING INTERCOM SYSTEM COORDINATION TO BE BY SBH.

ROOM FINISH AND MATERIAL SCHEDULE

			FLO	OR	BA	SE						WAL	LS							CEILING			CASE	<i>N</i> ORK		REMARKS
R	RM #	NAME						NORTH			EAST			SOUTH			WEST					CABIN	IETRY	COUN	ITERTOP/	
			UNDERLAY	FIN FLR	MATERIAL	FINISH	MATERIAL	FINISH	REVEAL	MATERIAL	FINISH	REVEAL	MATERIAL	FINISH	REVEAL	MATERIAL	FINISH	REVEAL	MATERIAL	FINISH	неіснт	MAPERIAL	FINISH	MATERIAL	HSINH	
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2	201	NEW CORRIDOR	HALEX	L1	B1	PTD	GWB	PTD	_	GWB	PTD	_	GWB	PTD	_	GWB	PTD	_	5/8 GWB	P-2	10'-0"	-		17		_
																								/		
2	202	KIT/LIV	HALEX	L1	B1	PTD	GWB	PTD	_	GWB	PTD	_	GWB	PTD	_	GWB	PTD	_	5/8 GWB	P-2	PER RCP	-		X		
2	203	BEDROOM	HALEX	C1	B1	PTD	GWB	PTD	_	GWB	PTD		GWB	PTD	-	GWB	PTD		5/8 GWB		PER RCP	_	/	<u> </u>		
2	204	BATHROOM	HALEX	L1	B1	PTD	GWB	PTD	_	GWB	PTD	_	GWB	PTD	_	GWB	PTD	_	5/8 GWB	P-2	PER RCP	_	<u> </u>	\sqcup		
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-	205	LIV	HALEX		B1	PTD	GWB	PTD	_	GWB	PTD	-	GWB	PTD	_	GWB	PTD		5/8 GWB		PER RCP		/ 		\ 	
\vdash	206 207	BEDROOM BATHROOM	HALEX HALEX		B1 B1	PTD PTD	GWB GWB	PTD PTD	- -	GWB GWB	PTD PTD	- <u>-</u>	GWB GWB	PTD PTD	_	GWB GWB	PTD PTD	•	5/8 GWB 5/8 GWB		PER RCP			<u> </u>	\vdash	
1	207	KITCHEN	HALEX		B1	PTD	GWB	PTD	- _	GWB	PTD	- <u>-</u>	GWB	PTD	<u>-</u>	GWB	PTD		5/8 GWB		PER RCP	 			+	
۲	200	RITCHEN	ITALEA	<u> </u>	+ 1 1		GWB	- 10	-	346	ייין וייין	 	JUND	רוט		JOWD	1 510	-	J/0 GWB	r - Z	FER NOP	- /			$\vdash \vdash$	
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\vdash					+		 															/			 \	

BASE BID:

C2 NOT USED

FLOOR FINISHES (SEE SCHEDULE AND PLAN)

C1 NYLON LOOP OVER PAD OVER PLYWD DECK

L3 LVT PLANK OVER HALEX "COMPOSITE" 4x4
UNDERLAYMENT AT LANDINGS.

L1 LVT PLANK OVER HALEX "COMPOSITE" 4x4 UNDERLAYMENT.

L2 12 x 12 LVT OVER HALEX "COMPOSITE" 4x4 UNDERLAYMENT.

ROPPE TYPE 16 VINYL TREAD/RISER WITH ABRASIVE INSERT AT STAIRS. COLOR TO BE DETERMINED.

5/8" x 5" COLONIAL WITH WOOD BASE SHOE EXCEPT AT CARPET PAINTED. COLOR: TBD

S-1 STAIN 1: TBD

P-1 PAINT 1: NEW GWB - PRIME + 2 COATS EGGSHELL / COLOR TBD

P-2 PAINT 2: NEW GWB W/ SMOOTH FINISH - PRIME + 2 COATS FLAT / COLOR TBD P-3 PAINT 3: NEW GWB - PRIME + 2 COATS EGGSHELL / ACCENT COLOR TBD

PER, SCHEDULE ORIGINAL MRO SHOWN DASHED NEW LS THRESHOLD BB NOT RATED RATED PER SCHEDULE
1X WOOD FRAME
FOR 2x4 WALL
w/ 5/8 GWB NOT RATED 1X WOOD FRAME FOR 2x4 WALL w/ 5/8" GWB NARROW STEEL FRAME FOR MASONRY RO NOT RATED
ALUM. STOREFRONT
TEMPERED GLASS
BLACK
CLOSURE & LEVERSET 20 MIN 1 3/4 SOLID CORE, FLUSH PANEL, MAPLE, NAT. FIN. HARDWARE PER SCHED. NOT RATED
1 3/8 SOLID CORE,
FLUSH PANEL, MAPLE,
NAT. FIN.
HARDWARE PER SCHED.

DOOR & FRAME TYPES

EXISTING ALUM. WINDOW (FIELD MULL VARIES) NEW WD JAMB EXTENIONS. INT TRIM TO MATCH DR TRIM

WINDOW TYPES

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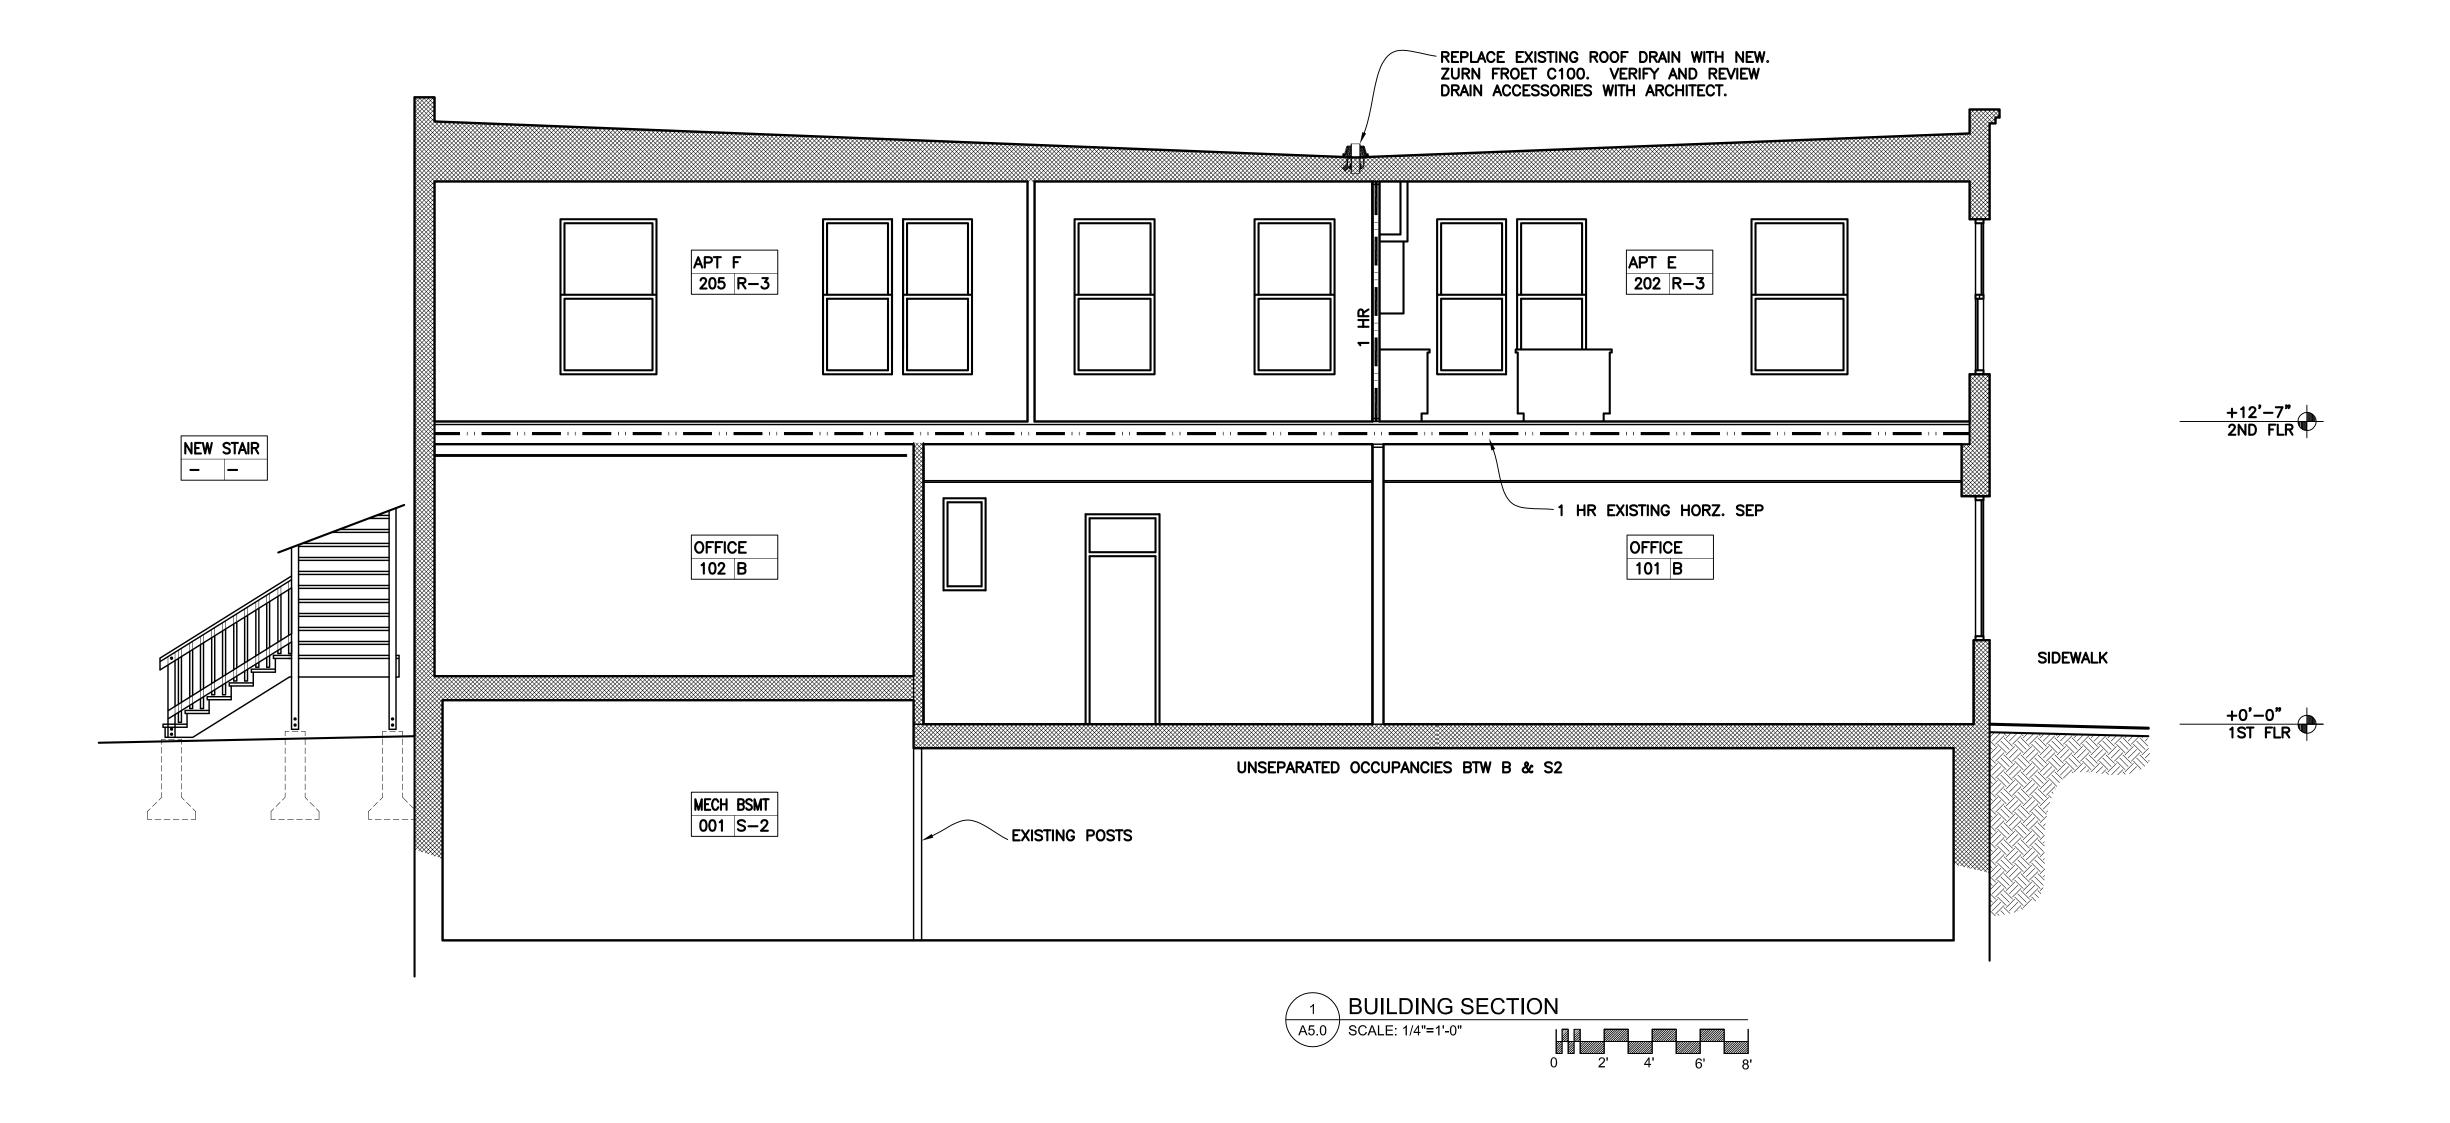
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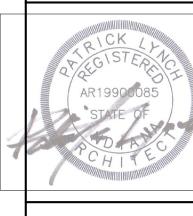
2 07-01-20 R-3 FROM R-2

Schedule

Sheet Number: A3.1



SOUTH BEND HERITAGE FOUNDATION



CHAPIN STREET, SOUTH BEND, IN 46601

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Date: AUG. 19, 2020


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Drafting:
Approval: PDL

Building Section

Sheet Number:

A5.0



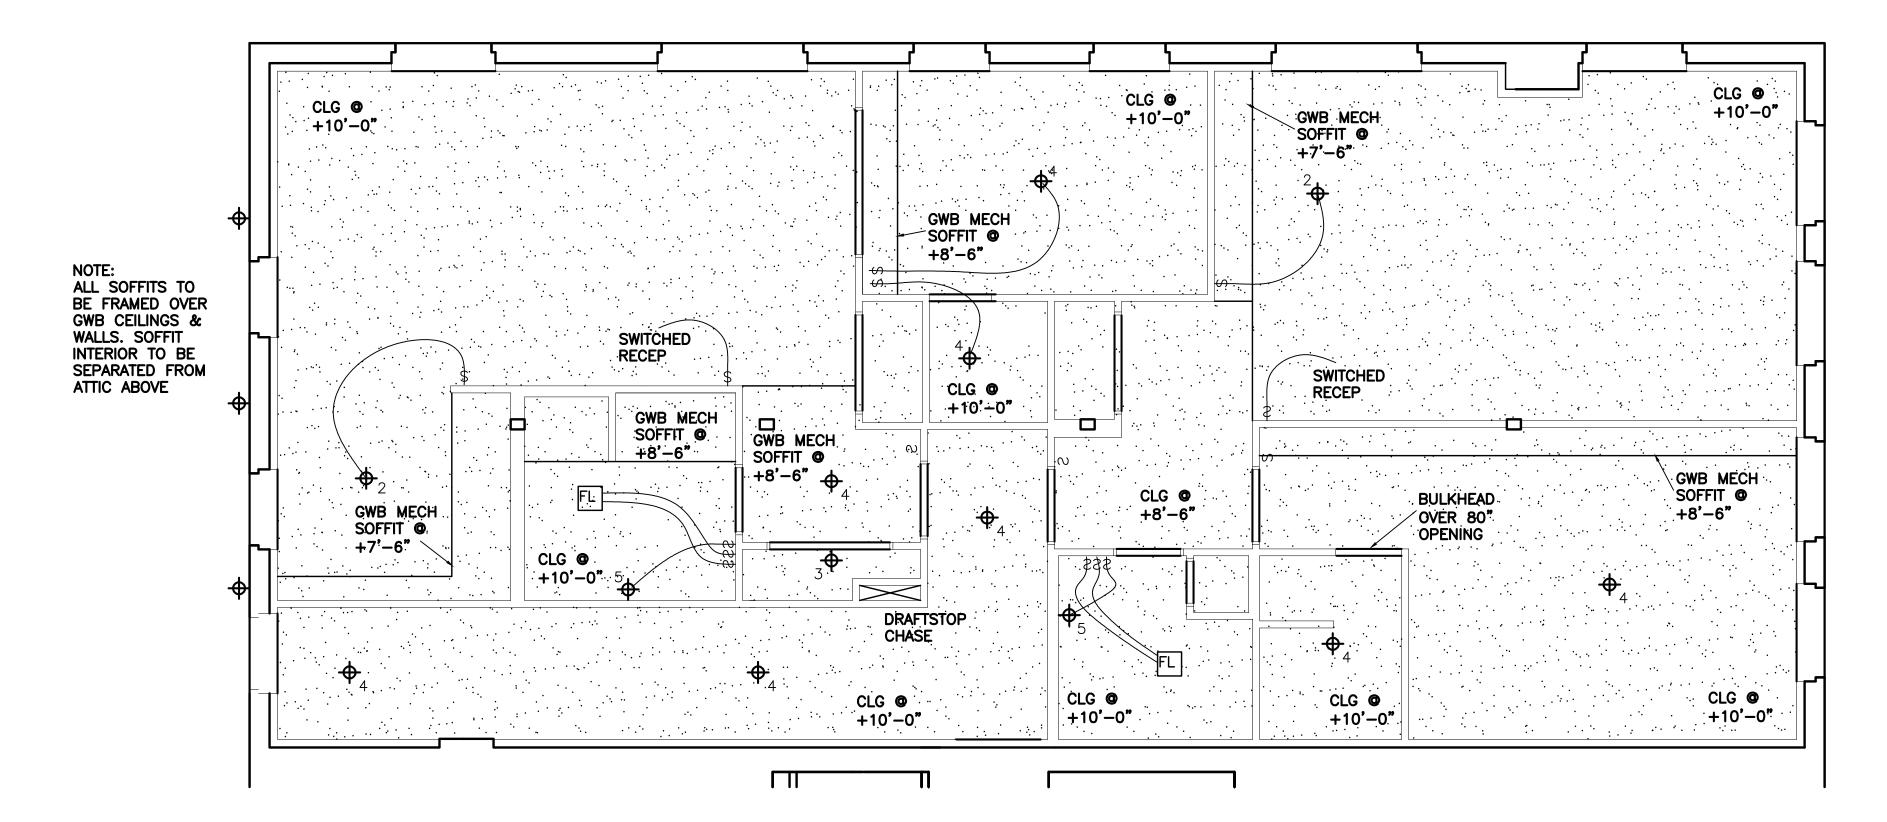



GENERAL NOTES:

ALL ELEC. BOXES TO BE RECESSED SUCH THAT DEVICE OR FIXTURE IS FLUSH WITH ADJACENT FINISHED SURFACE. NO SURFACE MOUNTED BOXES PERMITTED UNLESS SPECIFICALLY NOTED AS WIREMOLD.

REFER TO REFLECTED CEILING PLAN FOR LIGHTING.

PROVIDE ROOFTOP GFIC RECEPTACLE PER ROOF PLAN.

Color of switches, duplex receptacles, and similar devices

and plates to be standard ivory unless noted otherwise.

C2 INTERCOM LOBBY DIALER UNIT MNFR: "LINEAR" AE100 AND DOOR MAGNETIC RELEASE

CABLE AND DATA/TELE DEVICES IN 2 SEPARATE SIDE BY SIDE BOXES. EC TO PROVIDE TENANT TERMINATION JACKS FOR BOTH CABLE & CAT-6, EACH CAT-6 COMMUNICATION WIRE TO BE HOME-RUN TO TELEPHONE BOARD IN BSMT. EACH RG-60/U COAXIAL CABLE HOME-RUN TO EC PROVIDED TERMINATION BLOCK IN BASEMENT. EC IS RESPONSIBLE FOR TERMINATION OF TELE/DATA PAIRS AT A BASEMENT 12-PORT PATCH PANEL. EC TO CONNECT TELE/DATA WIRING TO THE NID (NETWORK INTERFACE DEVICE) DEMARKATION POINT.

 \mathbf{P}_{S} DUPLEX RECEPTACLE +18" AFF UON. LOWER RECEP SWITCHED PER LIGHTING PLAN

DUPLEX RECEPTACLE +18" AT WALLS. +42 ABOVE KIT BACKSPLASH AND BEHIND REFRIGERATOR.

⇒ GFIC PROTECTED RECEP +42 AT KIT BACKSPLASH. +36 AT BATHROOM LAV. +34 BELOW COUNTER AT KIT ISLANDS.

•OR RANGE OUTLET 208V WITH SEPARATE 120V CONNECTION TO 30" RANGE HOOD. RANGE HOOD TO BE BROAN AND VENTED TO EXTERIOR. PROVIDE HOOD WITH LED APPLIANCE LAMP

HOOD FAN & LIGHT TO BE SWITCHED AT FIXTURE. DW PROVIDE RECEP IN SINK BASE CABINET. DISHWASHER TO BE HARDWIRED TO THIS RECEP. GARBAGE DISPOSAL TO BE PLUGGED INTO SAME RECEP. THIS SYMBOL INCLUDES A SINGLE POLE SWITCH LOCATED

ABOVE THE COUNTERTOP FOR GARBAGE DISPOSAL OPERATION.

• DWa SAME AS • DW BUT ADA HEIGHT

●D ELEC. CLOTHES DRYER. REFER TO APPLIANCE SCHEDULE.

APARTMENT BREAKER PANEL PER SPEC. REFER TO PAGE E2.0.

EMERGENCY LIGHTING W/ BATTERY BACKUP MNFR: LITHONIA PRODUCT: ELM2 LED COLOR: WHITE

SMOKE DETECTOR - HARDWIRED W/ BATTERY BACKUP. WITH AUDIBLE BASE. NOT TIED TO BLDG FACP. DUAL DETECTION TYPE. INTERCONNECTED WITHIN EACH APARTMENT PER CODE.

②3 STROBE, EITHER AS AN ACCESSORY TO THIS DEVICE OR BUILT INTO THE DEVICE, IS REQUIRED AT THIS LOCATION. FIRE BELL PROVIDED BY SPRINKLER CONTRACTOR AND INSTALLED BY ELECTRICAL CONTRACTOR.

WALL MOUNTED FIXTURE. MARKED NUMBER INDICATES TYPE PER SCHEDULE

SURFACE APPLIED FIXTURE. MARKED NUMBER INDICATES TYPE PER SCHEDULE

FLUORESCENT FIXTURE - EXISTING

FAN/LIGHT COMBO & SWITCH CONTROL

NOTE: DOUBLE POLE SWITCH REQ'D FOR HVAC

DEVICE INDICATED TO BE SURFACE MOUNTED BOX IN METALIC RACEWAY. COORD HT AFF IN FIELD. RUN POWER SEPARATE FROM DATA/COMM IN PARALLEL

FAN - EXISTING


LED EXIT INDICATOR AS NOTED ABOVE. COMBINE WITH CODE REQ'D PATHWAY LIGHTING AT EXTERIOR ACTIVATED BY EXIT INDICATOR BATTERY.

EXTERIOR: LITHONIA "AFFINITY" MODEL: AFN-DB-EXT.

WATTS "WM-26" WALL MOUNT RESTRAINT BRACKET.

INTERIOR UNIT IS POWERED VIA ROOFTOP UNIT. ISOLATE ROOFTOP FROM INTERIOR UNIT WITH DOUBLE POLE WALL SWITCH.

SWITCH - 120VAC DOUBLE POLE. WALL MOUNT AT +8'-6" AFF AND ABOVE ACT CLG. CLEARLY LABEL SWITCH AS HVAC DISCONNECT FOR INTERIOR COMPONENT.

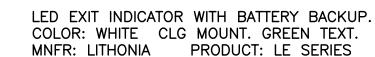

MOTION FLOOD LIGHT W/ SWITCH OVERRIDE

VENT FAN & SWITCH/CONTROL. REFER TO SCHEDULE

REFER TO SCHEDULE

UNIT LOCATED ADJ TO INT UNIT. COORD. W/ HVAC. ₩IREMOLD/LEGRAND 500 OR 700 SERIES.

RACEWAY.

FAN/LIGHT - NEW DUCT PER HVAC PLAN

INTERIOR: COMPATIBLE LED EXIT INDICATOR WALL HUNG ELEC. WATER HEATER ABOVE ACT CEILING.

LOWBOY 28 GALLON, 240V. CRAFTMASTER MHE2F30LD045V OR APPROVED EQUAL WITH SIDE CONNECTIONS. (NOT TOP)

HVAC MINI-SPLIT ELECTRICAL CONNECTION.

BEND HERITA

REVISIONS 04-13-20 BLDG SECTIO 07-01-20 R-3 FROM R-2

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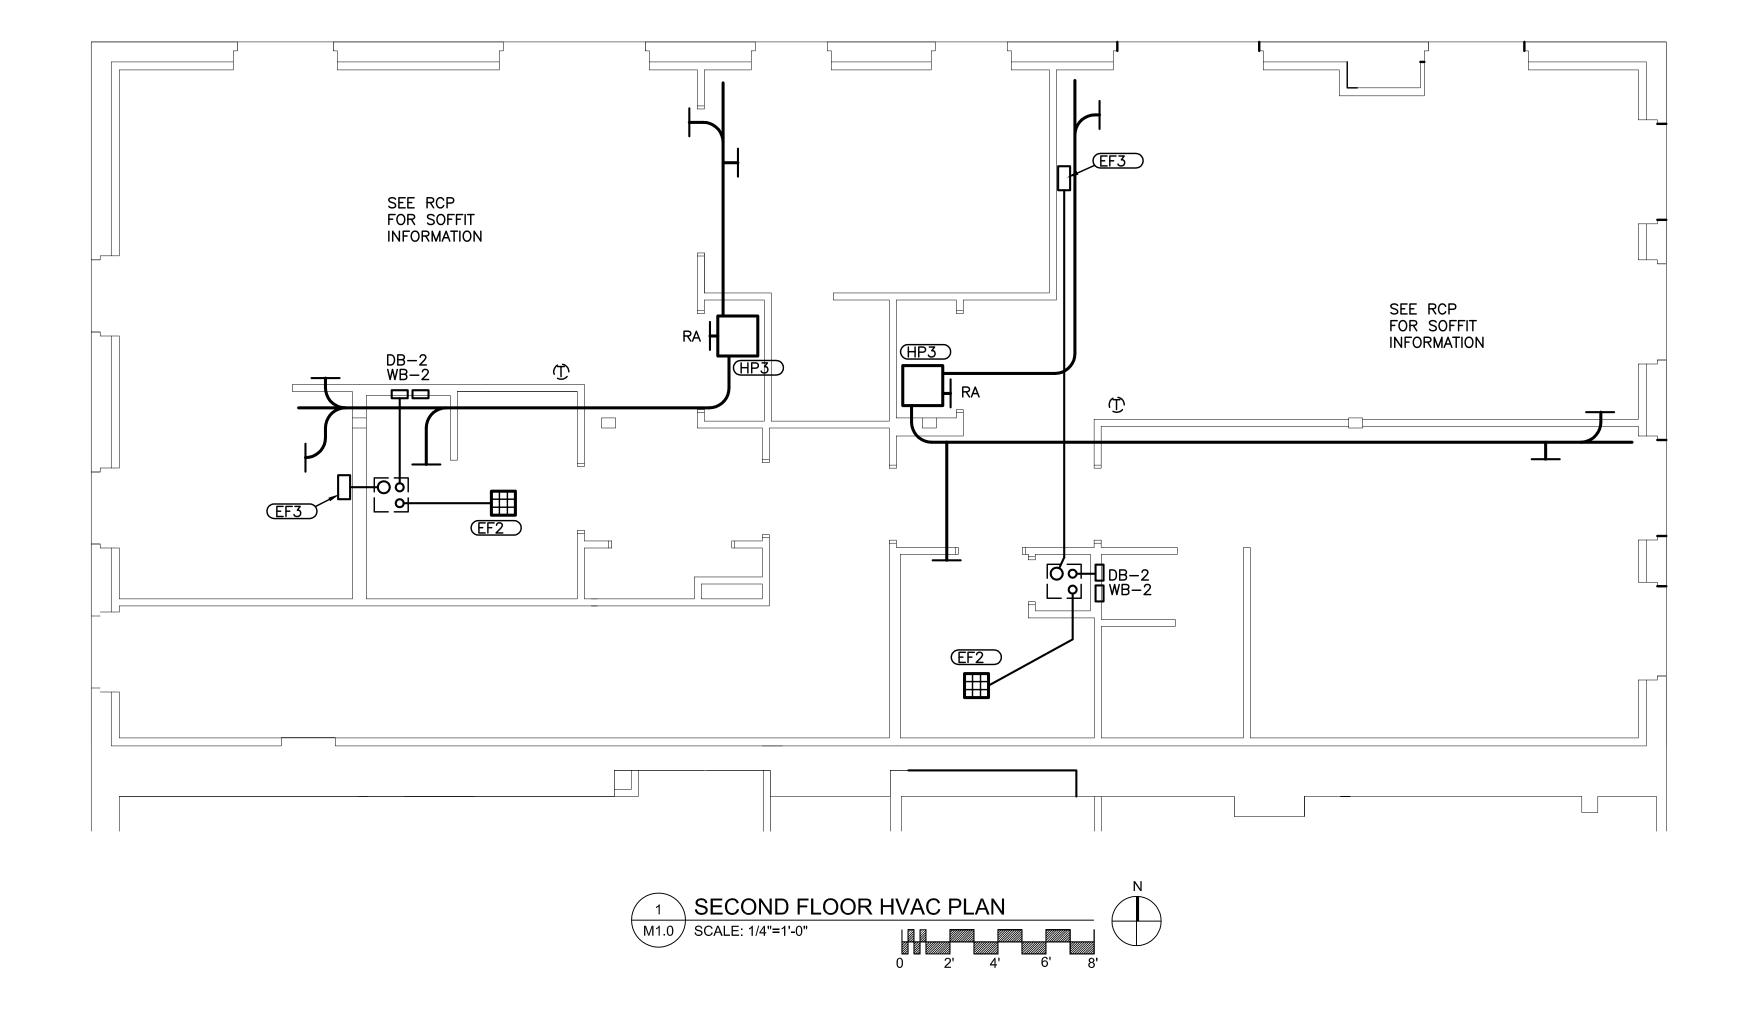
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|Lighting & Reflected Ceiling Plan

Sheet Number: A6.



SECOND FLOOR HVAC NOTES

2 ALL RECESSED DRYER BOXES TO BE APPROVED FOR USE IN 1 HOUR RATED WALL.

(HP3) MITSUBISHI - 30K BTU P-Series 19.0 SEER Model: PVZ-A30NHA w/ HYPER HEAT

(EF1) NOT USED

EF3 30" RANGE HOOD EXHAUST FAN — BROAN DUCTED TO EXTERIOR. WHITE.

FR1 NOT USED

(1) REFER TO ROOF PLAN FOR ROOF CURB VENTS.

3 RA FILTER GRILLES SIZED BY MC. APT. A IS CEILING MOUNTED. APT. B IS WALL MOUNTED.

4 METAL DUCT ONLY. NO FLEX DUCT PERMITTED THIS SYSTEM FOR SUPPLY, RETURN, OR EXHAUST AIR. ALL DUCTS TO BE AIR SEALED.

5 EC TO PROVIDE DOUBLE POLE SWITCH FOR EACH INTERIOR HVAC UNIT. LOCATE SWITCH IN J-BOX ABOVE CEILING

(HP1) NOT USED

(HP2) NOT USED

(HP4) NOT USED

EF2 EXHAUST FAN — FAN LIGHT COMBINATION — BROAN ZB80L MOUNTED IN ACT.

EF4 NOT USED

CHAPIN 301 SO. CHAF

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REVISIONS 1 04-13-20 BLDG SECTION 2 07-01-20 R-3 FROM R-2


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2nd Floor HVAC Plan

M1.0



HVAC flex condensate drain by MC where occurs. Insert flex drain into PB installed 1.5" standpipe such that the end of the flex drain has a 12" min. vertical length. Terminate standpipe within 12" of HVAC ceiling unit or at wall plane behind wall unit. Coordinate final connection in the field. (Standpipe may also be plumbed at a different trapped drain closer to HVAC head unit. Coord. with MC.)

HVAC contractor (MC): provide and install dryer vent cap at exterior, cap per spec with integral backdraft damper. do not exceed max. allowable duct length and number of bends specified by dryer coodinate hole at exterior with GC and/or siding contractor.

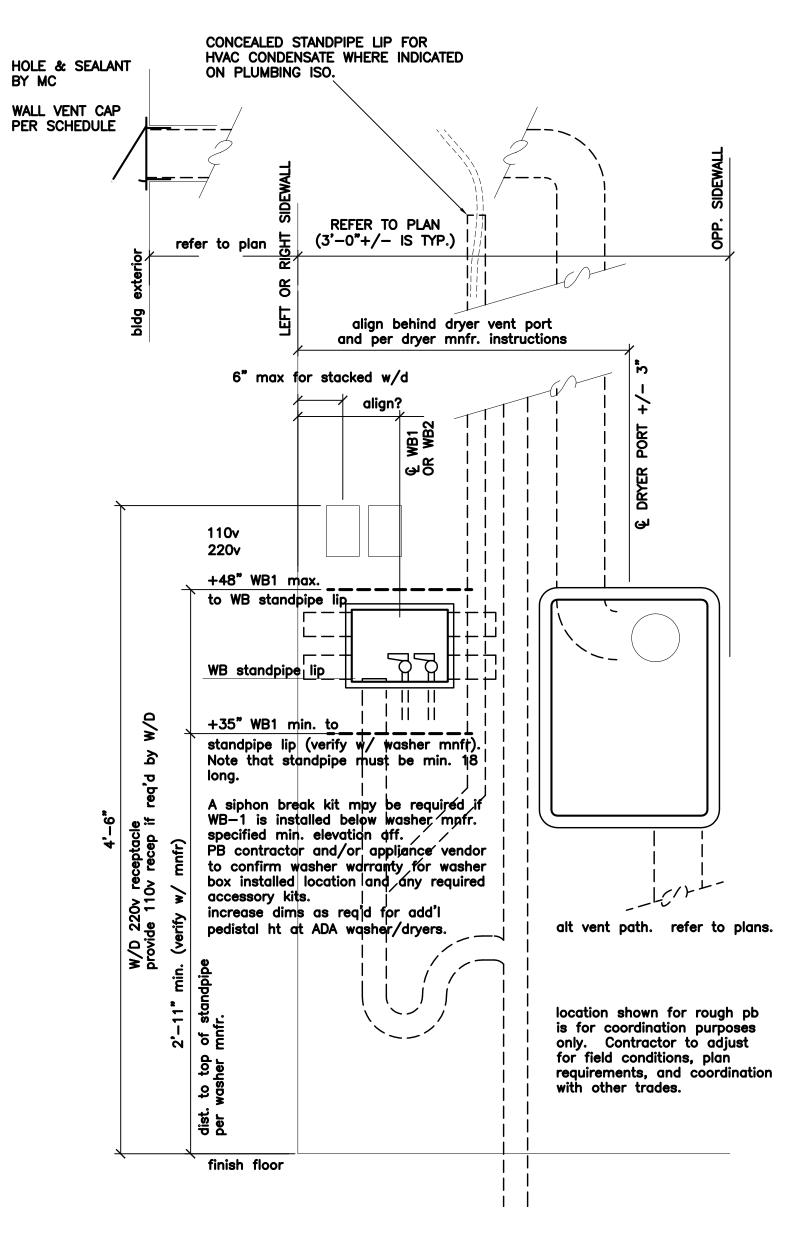HVAC contractor responsible for sealing and draftstopping around EXT WALL penetration. Refer to weathersealing spec.
Duct installation and joints per spec.

general note: all mech contractors to coord. respective rough—ins at a single mutually agreed upon W/D location for approval by GC before proceeding with additional rough ins.


REFER TO GENERAL SPECIFICATIONS FOR FIRE SEALANT AT VERTICAL PENETRATIONS AND METAL NAIL GUARD PLATES ON FRAMING.

HVAC contractor (MC): DB-1 Recessed dryer box for not rated DB-2 Recessed dryer box for rated wall. Contractor to verify height of vent port for spec'd dryer unit — final verification of installed location of recessed dryer box is resp of HVAC contractor. Dryer installation manual to be provided by owner/architect at MC contractor's request. refer to plan for suggested duct route. note that some ducts may be routed from the top or bottom of the dryer box.

plumbing contractor (PB): WB-1 Recessed washer box for non-rated wall assembly. WB-2 Recessed washer box for rated Vfy ht of lip to spec'd unit — final verifation prior to installation of box is resp of PB contractor accessory product may be avail from W/D mnfr. to allow for a lower box

electrical contractor (EC): coord. power and recep. type with W/D model. Whip will be provided by W/D

"LNDRY-1" ROUGH IN DIAGRAM MIRROR AS REQ'D PER COORDINATION; W/D CONFIGURATIONS; FIELD CONDITIONS

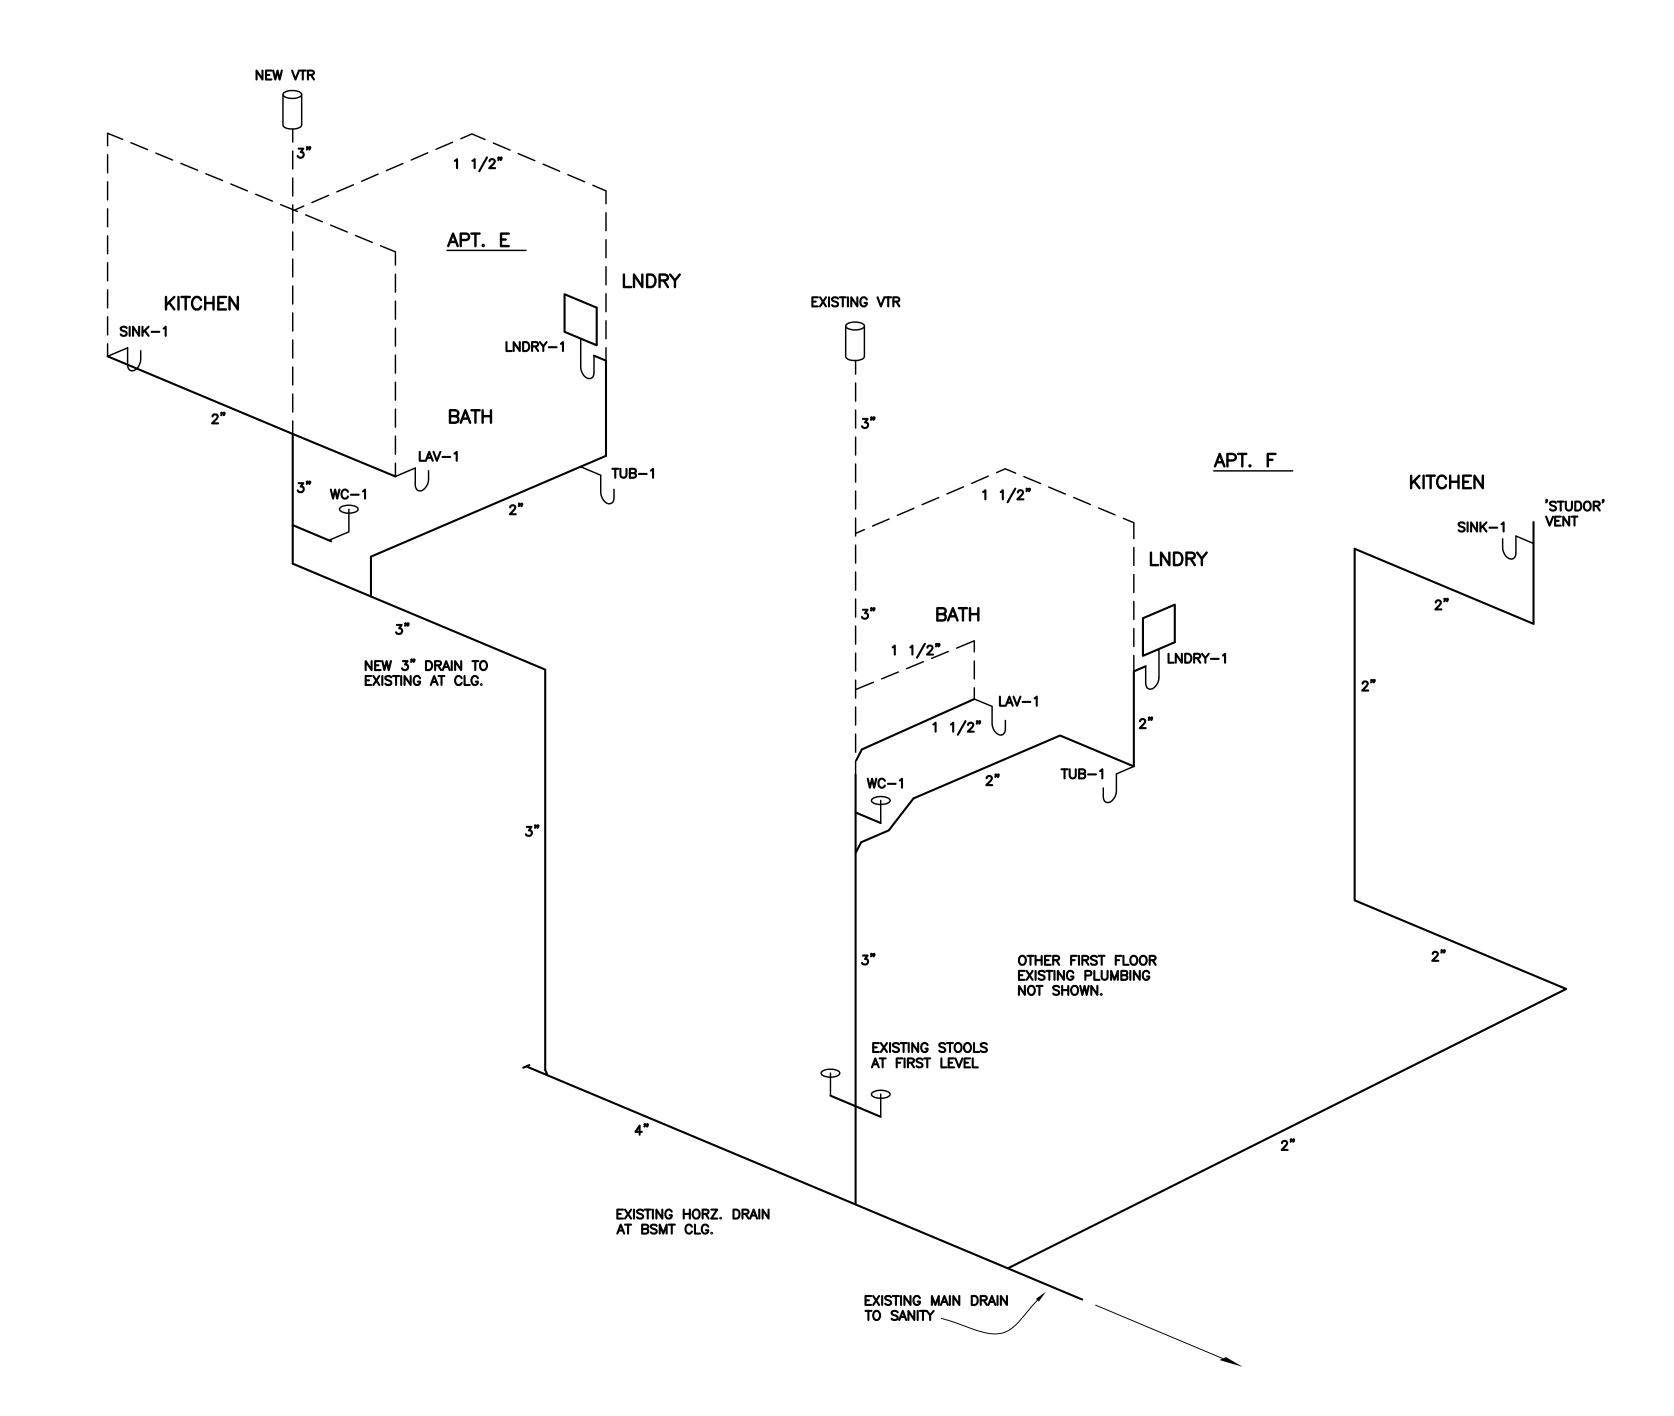

1 PB WASTE ISO E & F (301 CHAPIN) P1.0 SCALE: NTS

VENTING SHOWN DASHED

2 PLUMBING SCHEDULE P1.0

TUB/SHOWER DRAIN WATER CLOSET - FLOOR MOUNTED EXISTING WATER CLOSET - NO WORK FLOOR DRAIN LAV SINK AND ADA FAUCET RECESSED LAUNDRY BOX SS KITCHEN SINK W/ GAR DISP

EXISTING MOP SINK CLEAN OUT

SOUTH BEND HERITAGE FOUNDATION

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HAPIN 11 SO. CHAI

REVISIONS


04-13-20 BLDG SECTION 07-01-20 R-3 FROM R-2

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AUG. 19, 2020 Job Number: Drafting: -Approval: PDL

Plumbing Isometric

Sheet Number:

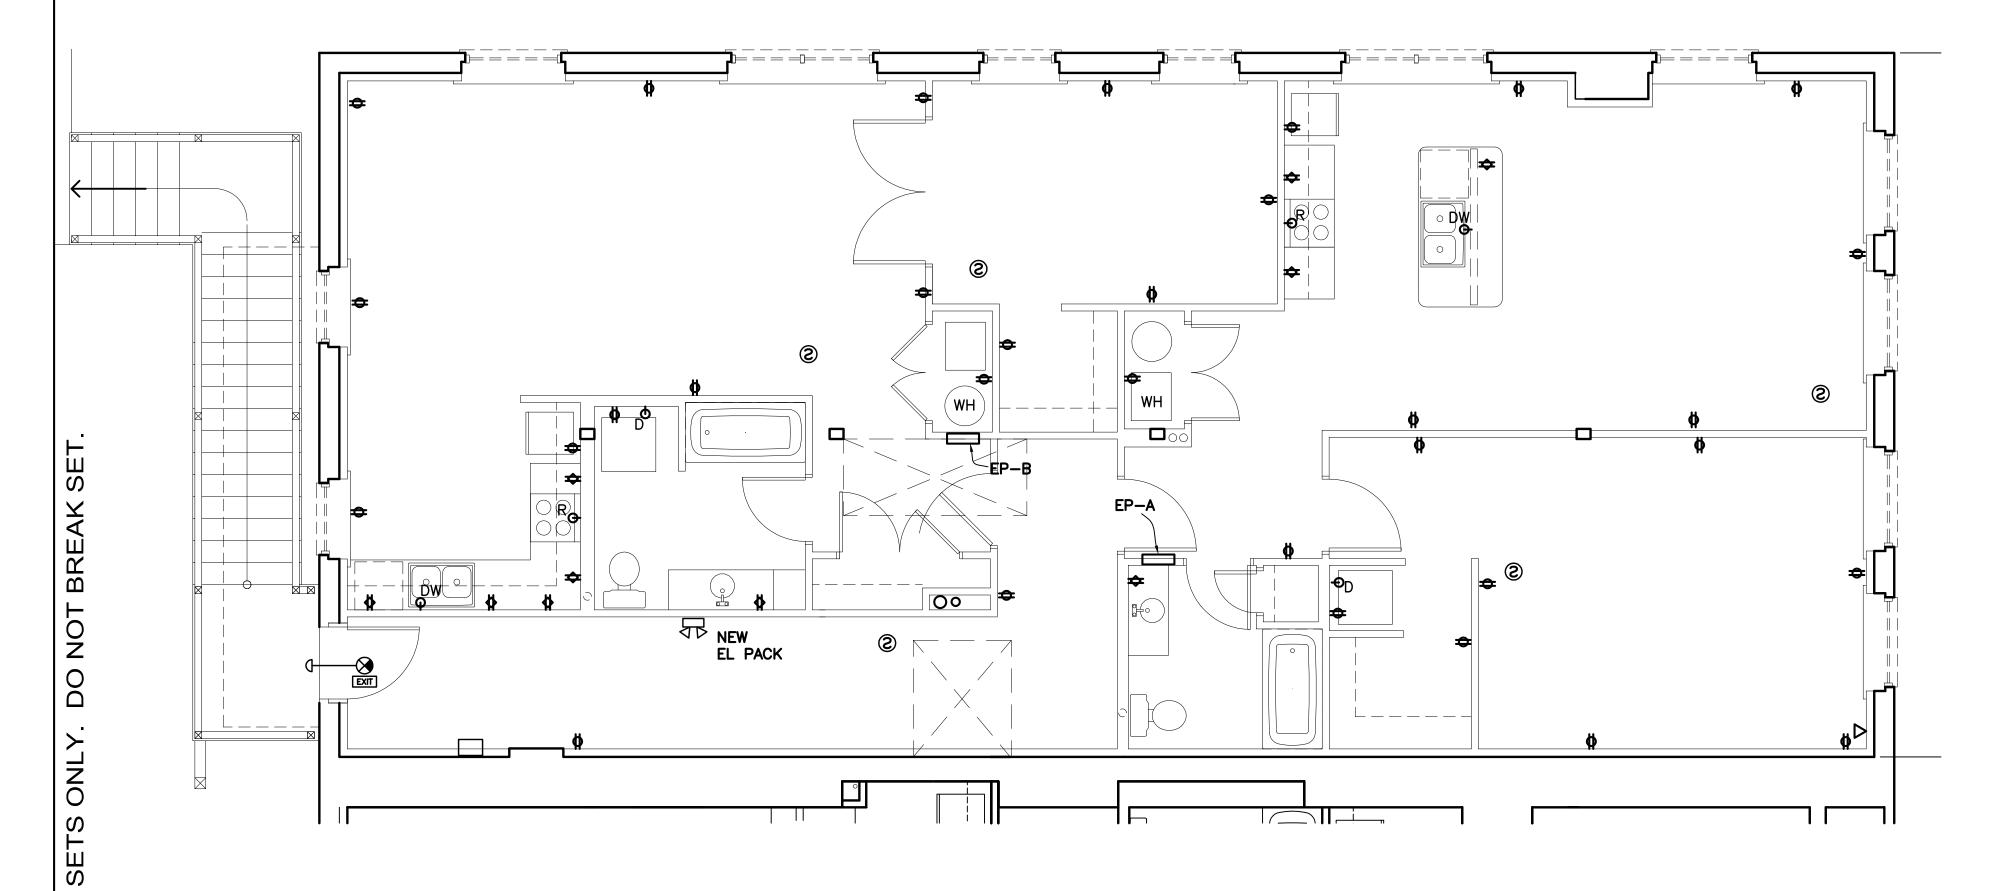

SECOND FLR POWER & DATA PLAN

\ ELECTRIC DEVICE SCHEDULE

GENERAL NOTES:

ALL ELEC. BOXES TO BE RECESSED SUCH THAT DEVICE OR FIXTURE IS FLUSH WITH ADJACENT FINISHED SURFACE. NO SURFACE MOUNTED BOXES PERMITTED UNLESS SPECIFICALLY NOTED AS WIREMOLD.

REFER TO REFLECTED CEILING PLAN FOR LIGHTING.

PROVIDE ROOFTOP GFIC RECEPTACLE PER ROOF PLAN.

Color of switches, duplex receptacles, and similar devices

and plates to be standard ivory unless noted otherwise.

C2 INTERCOM LOBBY DIALER UNIT MNFR: "LINEAR" AE100

AND DOOR MAGNETIC RELEASE

CABLE AND DATA/TELE DEVICES IN 2 SEPARATE SIDE BY SIDE BOXES. EC TO PROVIDE TENANT TERMINATION JACKS FOR BOTH CABLE & CAT-6, EACH CAT-6 COMMUNICATION WIRE TO BE HOME-RUN TO TELEPHONE BOARD IN BSMT.

EACH RG-60/U COAXIAL CABLE HOME-RUN TO EC PROVIDED TERMINATION BLOCK IN BASEMENT.

EC IS RESPONSIBLE FOR TERMINATION OF TELE/DATA PAIRS AT A BASEMENT 12-PORT PATCH PANEL.

EC TO CONNECT TELE/DATA WIRING TO THE NID (NETWORK INTERFACE DEVICE) DEMARKATION POINT.

OUPLEX RECEPTACLE +18" AFF UON.
LOWER RECEP SWITCHED PER LIGHTING PLAN

DUPLEX RECEPTACLE +18" AT WALLS. +42 ABOVE KIT BACKSPLASH AND BEHIND REFRIGERATOR.

⇒ GFIC PROTECTED RECEP +42 AT KIT BACKSPLASH. +36 AT BATHROOM LAV. +34 BELOW COUNTER AT KIT ISLANDS.

OR RANGE OUTLET 208V WITH SEPARATE 120V CONNECTION TO 30" RANGE HOOD.

RANGE HOOD TO BE BROAN AND VENTED TO EXTERIOR.

PROVIDE HOOD WITH LED APPLIANCE LAMP

HOOD FAN & LIGHT TO BE SWITCHED AT FIXTURE.

PROVIDE RECEP IN SINK BASE CABINET. DISHWASHER
TO BE HARDWIRED TO THIS RECEP.
GARBAGE DISPOSAL TO BE PLUGGED INTO SAME RECEP.
THIS SYMBOL INCLUDES A SINGLE POLE SWITCH LOCATED
ABOVE THE COUNTERTOP FOR GARBAGE DISPOSAL OPERATION.

€DWa SAME AS €DW BUT ADA HEIGHT

●D ELEC. CLOTHES DRYER. REFER TO APPLIANCE SCHEDULE.

EP-x APARTMENT BREAKER PANEL PER SPEC. REFER TO PAGE E2.0.

EMERGENCY LIGHTING W/ BATTERY
BACKUP MNFR: LITHONIA PRODUCT: ELM2 LED
COLOR: WHITE

SMOKE DETECTOR — HARDWIRED W/ BATTERY BACKUP. WITH AUDIBLE BASE. NOT TIED TO BLDG FACP. DUAL DETECTION TYPE. INTERCONNECTED WITHIN EACH APARTMENT PER CODE.

3 STROBE, EITHER AS AN ACCESSORY TO THIS DEVICE OR BUILT INTO THE DEVICE, IS REQUIRED AT THIS LOCATION.

FB FIRE BELL PROVIDED BY SPRINKLER CONTRACTOR AND INSTALLED BY ELECTRICAL CONTRACTOR.

LED EXIT INDICATOR WITH BATTERY BACKUP.
COLOR: WHITE CLG MOUNT. GREEN TEXT.
MNFR: LITHONIA PRODUCT: LE SERIES

WALL MOUNTED FIXTURE. MARKED NUMBER INDICATES
TYPE PER SCHEDULE

SURFACE APPLIED FIXTURE. MARKED NUMBER INDICATES TYPE PER SCHEDULE

MOTION FLOOD LIGHT W/ SWITCH OVERRIDE

FLUORESCENT FIXTURE - EXISTING

VENT FAN & SWITCH/CONTROL.
REFER TO SCHEDULE

FAN/LIGHT COMBO & SWITCH CONTROL REFER TO SCHEDULE

\$ SWITCH
NOTE: DOUBLE POLE SWITCH REQ'D FOR HVAC
UNIT LOCATED ADJ TO INT UNIT. COORD. W/ HVAC.

WIREMOLD/LEGRAND 500 OR 700 SERIES.
DEVICE INDICATED TO BE SURFACE MOUNTED BOX IN
METALIC RACEWAY. COORD HT AFF IN FIELD.
RUN POWER SEPARATE FROM DATA/COMM IN PARALLEL RACEWAY.

FAN - EXISTING

FAN/LIGHT — NEW
DUCT PER HVAC PLAN

LED EXIT INDICATOR AS NOTED ABOVE. COMBINE WITH CODE REQ'D PATHWAY LIGHTING AT EXTERIOR ACTIVATED BY EXIT INDICATOR BATTERY. INTERIOR: COMPATIBLE LED EXIT INDICATOR EXTERIOR: LITHONIA "AFFINITY" MODEL: AFN—DB—EXT.

WALL HUNG ELEC. WATER HEATER ABOVE ACT CEILING.
LOWBOY 28 GALLON, 240V. CRAFTMASTER MHE2F30LD045V
OR APPROVED EQUAL WITH SIDE CONNECTIONS. (NOT TOP)
WATTS "WM-26" WALL MOUNT RESTRAINT BRACKET.

HVAC MINI—SPLIT ELECTRICAL CONNECTION.
INTERIOR UNIT IS POWERED VIA ROOFTOP UNIT.
ISOLATE ROOFTOP FROM INTERIOR UNIT WITH
DOUBLE POLE WALL SWITCH.

\$ SWITCH - 120VAC DOUBLE POLE.
WALL MOUNT AT +8'-6" AFF AND ABOVE ACT CLG.
CLEARLY LABEL SWITCH AS HVAC DISCONNECT FOR
INTERIOR COMPONENT.

POWER / COMM PLAN NOTES

- 1 ASSUME TELE/DATA DEMARK IN BASEMENT OF 303. UTILITY SERVICE WORK COORDINATED BY
- 2 GC TO PROVIDE TWO 2" PVC CONDUITS TO ROOF FROM BASEMENT AS NOTED ON ROOF
- (3) PROVIDE 120VAC CIRCUIT AT TELE/DATA DEMARK IN BASEMENT OF 303 FOR CONTRACTOR USE. NO GFI.

4 NOT USED

5 NOT USED

ROOFTOP POWER PLAN NOT SHOWN. PROVIDE
(2) GFIC RECEPTACLES IN WEATHER BOXES ON

PROVIDE (2) 2" PVC CONDUIT TO ROOFTOP FOR DISH—TV VENDOR TO RUN COAXIAL TO PANEL IN 303 BSMT. REFER TO ROOF PLAN.

EC IS RESPONSIBLE FOR ANY ADDITIONAL RECEPS REQUIRED TO MEET CODE.

S. E & F BEND, IN 46601

BEND HERITA

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CHAPIN STREET APTS. E 301 SO. CHAPIN STREET, SOUTH BEND

REVISIONS

1 04-13-20 BLDG SECTIO
2 07-01-20 R-3 FROM R-2

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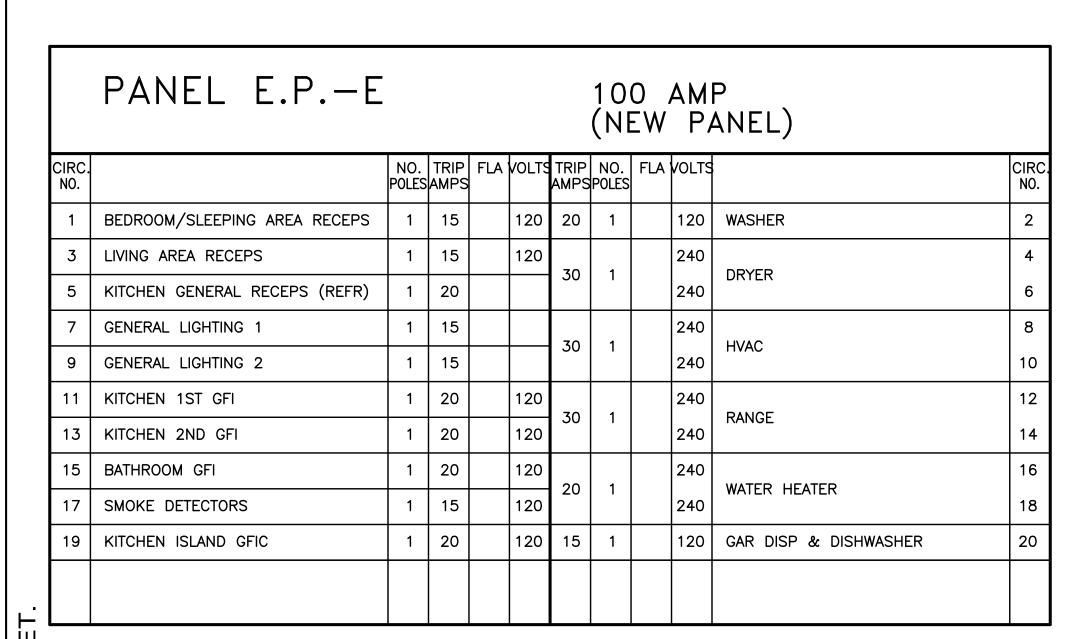
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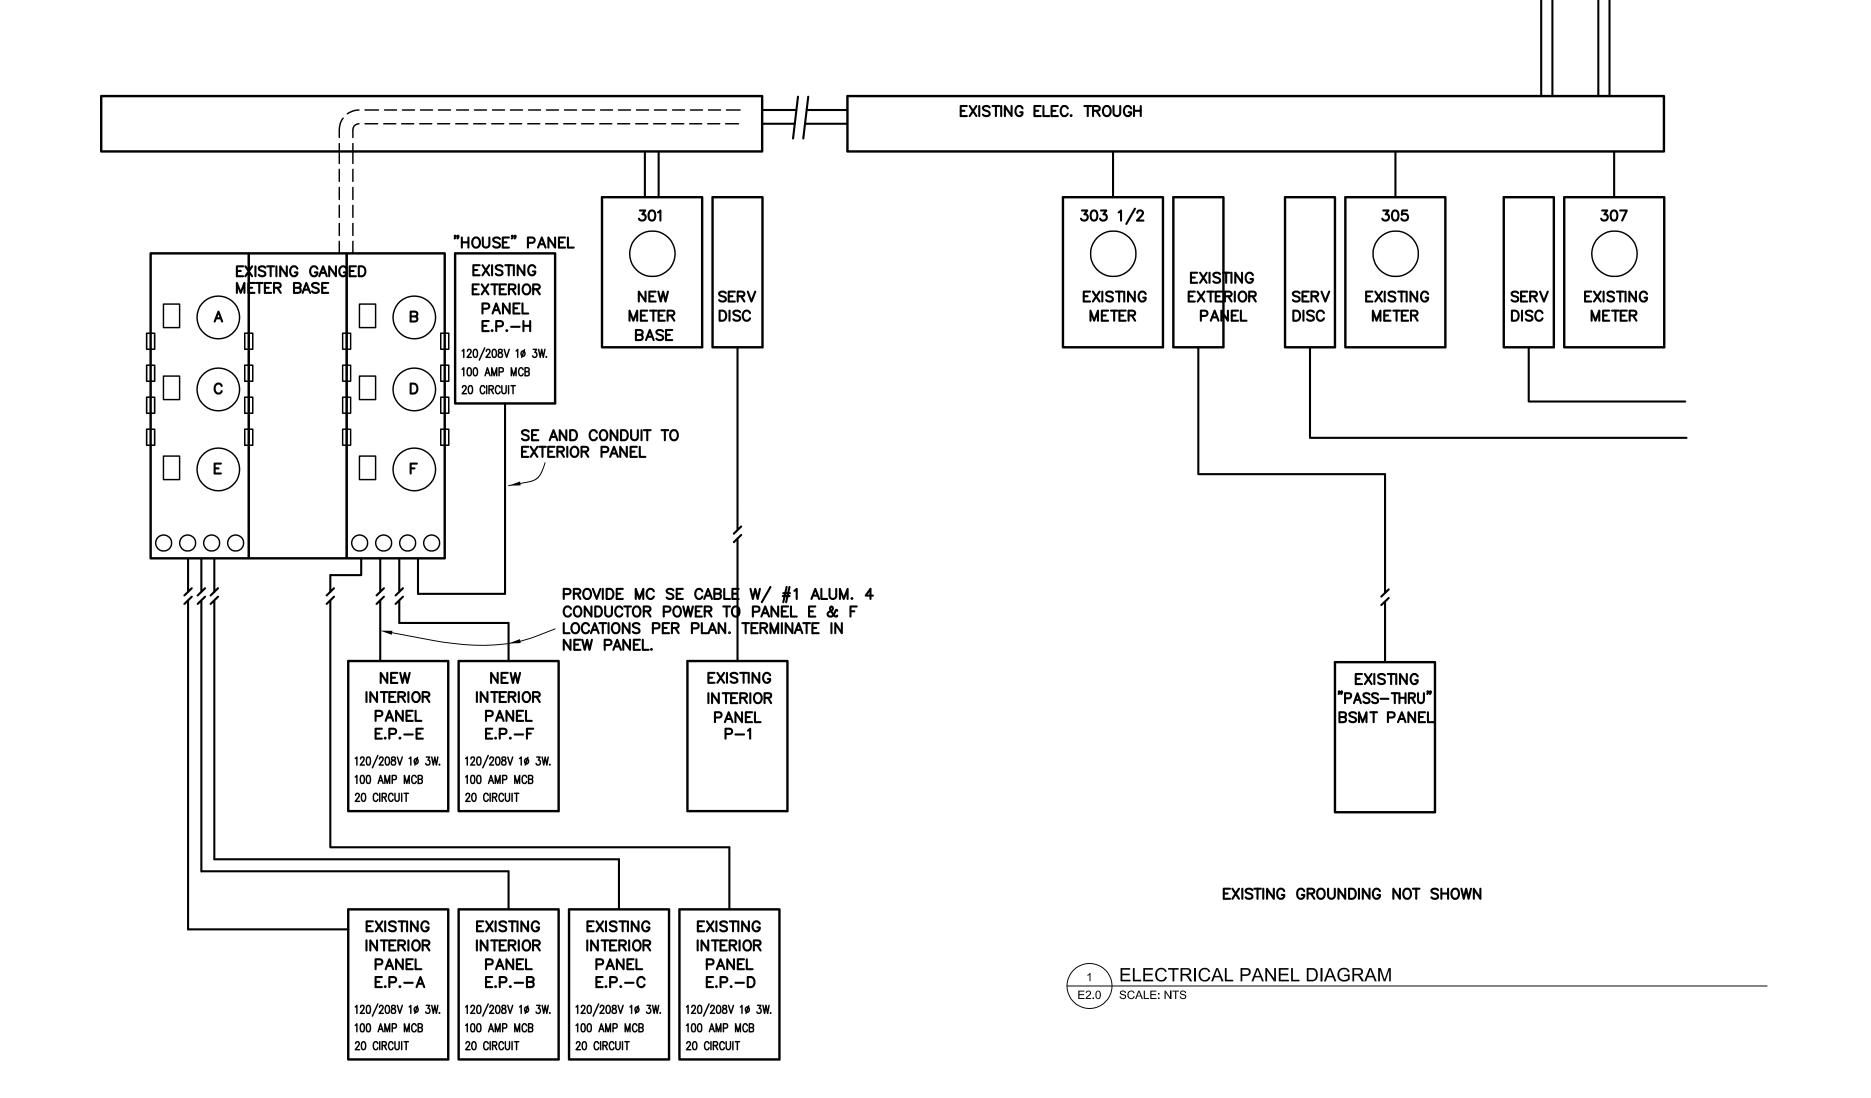
Second Floor Power/Data

Sheet Number:

E1.1



BREAK		PANEL E.PF	-					10 (N	O EW	AM P	P ANEL)	
NOT	CIRC. NO.		NO. POLES	TRIP AMPS	FLA	VOLTS	TRIP AMPS	NO. POLES	FLA	VOLTS		CIRC NO.
0	1	BEDROOM/SLEEPING AREA RECEPS	1	15		120	20	1		120	WASHER	2
	3	LIVING AREA RECEPS	1	15		120	30	1		240	DRYER	4
-	5	KITCHEN GENERAL RECEPS (REFR)	1	20			30	'		240	DRIER	6
ONLY	7	GENERAL LIGHTING 1	1	15			30	1		240	HVAC	8
	9	GENERAL LIGHTING 2	1	15			30	'		240	HVAC	10
SETS	11	KITCHEN 1ST GFI	1	20		120	30	1		240	RANGE	12
	13	KITCHEN 2ND GFI	1	20		120	30	'		240	RANGE	14
WHOLE	15	BATHROOM GFI	1	20		120	20	1		240	WATER HEATER	16
/HC	17	SMOKE DETECTORS	1	15		120	20	'		240	WATER HEATER	18
	19	KITCHEN ISLAND GFIS	1	20		120	15	1		120	GAR DISP & DISHWASHER	20
BUTE												




GROUND PER CODE.

	PANEL E.P.—H 100 AMP (EXHISTING PANEL)													
CIRC. NO.		NO. POLES	TRIP AMPS	FLA	VOLTS	TRIP AMPS	NO. POLES	FLA '	VOLTS		CIRC. NO.			
1	CORR LIGHTING SOUTH / EL LIGHTS	1	15		120	15	1		120	EXTERIOR LIGHTING	2			
3	CORRIDOR RECEPS	1	20		120						4			
5	INTERCOM/DIALER	1	15		120						6			
7	COMMON AREA SMOKE DETECTORS	1	15		120						8			
9	CORR LIGHTING NORTH / EL LIGHTS	1	15		120						10			
11											12			
13											14			
15											16			
17											18			
19											20			

SOUTH BEND HERITAGE FOUNDATION

EXISTING CONDUIT/MASTS TO OVERHEAD SERVICE

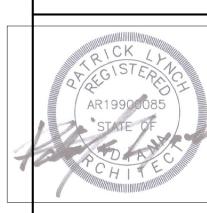

CHAPIN STREET, SOUTH BEND, IN 46601

REVISIONS

1 04-13-20 BLDG SECTION

2 07-01-20 R-3 FROM R-2

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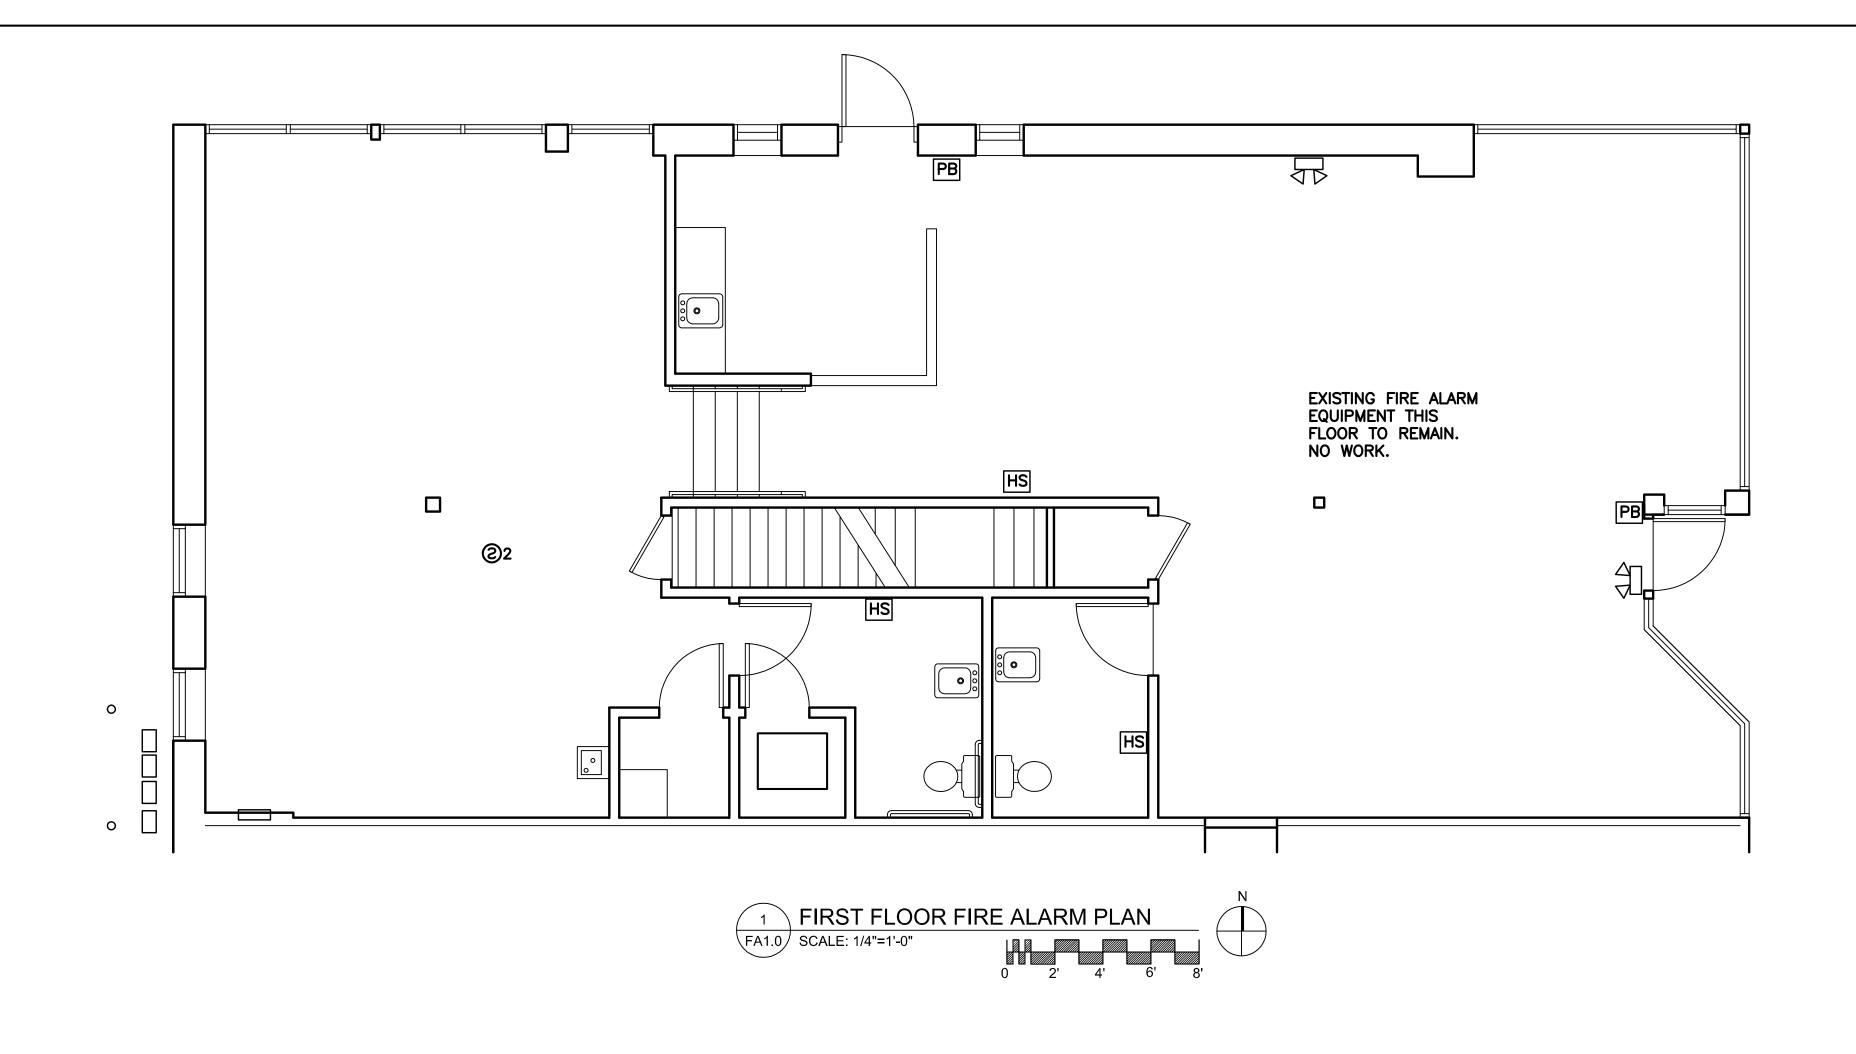
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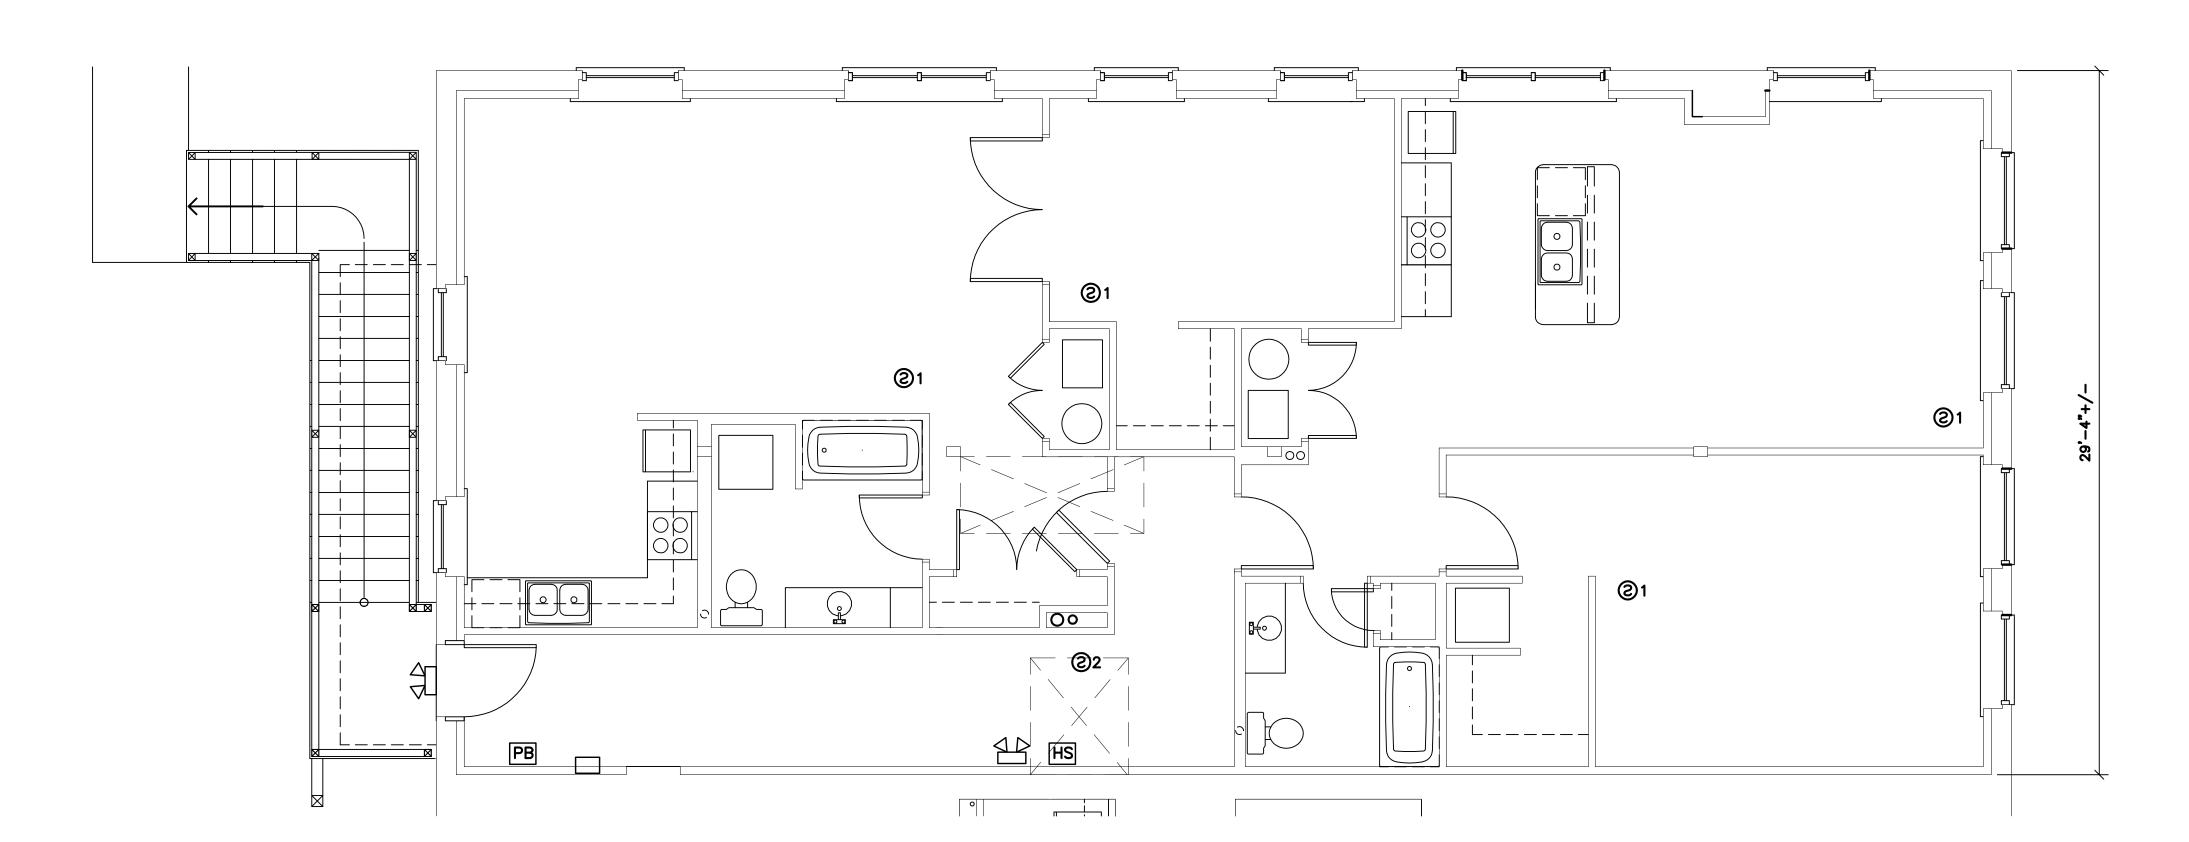
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Electrical Panels

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E2.0







FIRE DETECTION AND ALARM
FIRE ALARM SYSTEM TO COMPLY WITH IBC 907.3 & 907.9

REFER TO ARCHITECTURAL FOR EXIT INDICATORS AND EMERGENCY LIGHTING.

BASEMENT NOTE: TWO EXISTING TYPE 2 SMOKE DETECTORS ARE INSTALLED IN BASEMENT AND TIED TO BUILDING FACP.

- SMOKE & CO DETECTOR HARDWIRED W/BATTERY BACKUP. WITH AUDIBLE BASE. NOT TIED TO BLDG FACP. DUAL DETECTION TYPE. INTERCONNECTED PER CODE.
- ②2 SMOKE DETECTOR HARDWIRED W/ BATTERY BACKUP. TIED TO FACP. DUAL DETECTION
- PB MANUAL PULL STATION BOX
- ST STROBE MOUNT AT +84"
- HS HORN/STROBE MOUNT AT +84"
- FACP FIRE ALARM CONTROL PANEL
 ADDRESSABLE TYPE SYSTEM
 MNFR: TYCO SYSTEMS.
 FACP TO MONITOR SPRINKLER FLOW SWITCH



SOUTH BEND HERITAGE FOUNDATION

	REVI	SIONS	
	1		BLDG SECT
	2	07-01-20	R-3 FROM R
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Fire Alarm Plans

FA1.0